

Parks Design Standards

November, 2009



TABLE OF CONTENTS

1.0	INTRODUCTION	2
	1.1 PARKS CLASSIFICATION	2
2.0	INTENT OF THIS DOCUMENT	4
3.0	HOW TO USE PARKS DESIGN STANDARDS	5
	3.1 GENERAL	5
	3.2 SUBMISSION	5
	3.3 CONSTRUCTION COMPLETION CERTIFICATE/ FINAL ACCEPTANCE CERTIFICATE (CCC/FAC) PROCESS	6
4.0	LANDSCAPE ARCHITETECT'S RESPONSIBILITIES	8
5.0	PARKS DESIGN STANDARDS TABLE	10
6.0	PARKS AND OPEN SPACE CONSTRUCTION	13
	6.1 SITE PROTECTION, PREPARATION, TESTING AND RESTORATION	13
	6.2 CLEARING & GRUBBING	14
	6.3 EXCAVATION AND EMBANKMENT	14
	6.4 TOPSOIL & SEEDING	16
	6.5 SOIL MIX AND PLANTING	16
	6.6 PLANT MATERIALS	17
	6.7 MAINTENANCE	18
7.0	PARKS DESIGN STANDARD DETAILS	21
8.0	PARKS MAINTENANCE STANDARDS CHECKLIST	23

1.0 Introduction

Leduc County has provided public recreation services for decades to the residents of Leduc County and the greater Edmonton area. The goals of maintaining the quality of life and the environmental quality of its Parks and Open Spaces are driving forces that direct the management of these areas. By providing access to outdoor recreation opportunities, and protecting the natural environment for the benefit of future generations, Leduc County strives to meet and exceed those goals.

The County operates two regional parks which are Jubilee Park on Wizard Lake and Centennial Park on Joseph Lake. The County also maintains a number of district parks such as Mission Beach Day Use Park, Genesee Heritage Park and Nisku Recreation Centre Park. The smallest parks and open spaces, but also the most numerous are the local parks throughout the County which include many parks in subdivisions, community halls and small community parks such as Sunnybrook.

In addition, Leduc County also owns numerous parcels of undeveloped lands that are held as municipal reserves and environmental reserves, Public Utility Lots (PUL) and Storm Water Management Facilities (SWMF). Some of these reserve lands have the potential to provide future recreational services or play the role of conserving open space for environmental stewardship within the County. These spaces also serve as some of the only vegetated areas left unaltered in many of the new subdivisions being developed, and are remnants of the natural parkland vegetation that once existed.

The Parks and Recreation department receives referrals for input on new subdivision developments and improvements to its' current open spaces. These new developments are often more urban in nature than once occurred in the County. Residential densities are increasing in areas and the needs and expectations for parks and open space and the quality of facilities is increasing. To meet the increased development and ongoing upgrading of existing parks and open spaces the County has developed this comprehensive parks design standards document. This document establishes the quality for park development and redevelopment and shall be continually updated.

1.1 Parks Spaces Classification

Regional Parks – major outdoor recreational areas that provide facilities for County residents, as well as visitors from the greater Edmonton region and beyond. Can include campgrounds, large sports/recreational areas, historical/natural sites that provide a regional draw, etc.

District Parks – generally smaller in size than regional parks and provide outdoor opportunities to a more localized population (ie. Within 20kms).

Local Parks – small sites that meet the outdoor recreation needs of the residents in the immediate vicinity of the park (ie within 1-2 kms).

Industrial/Commercial Parks – sites within commercial/industrial/business parks that are small in size and used passively as picnic locations or areas for walking.

Arterial/Major Roads adjacent Subdivisions – areas where a major roadway runs adjacent to a subdivision and there is no distinct buffer between the two.

Linear Parks - sites that are used as a physical connection to parks, schools, and adjacent subdivisions. It may also include areas of natural habitat that provides a wildlife corridor.

Municipal Reserves - As per the Municipal Government Act.

Environmental Reserves - As per the Municipal Government Act.

Public Utility Lots (PUL's) (including Storm Water Management Facilities (SWMF's)) – As per the Municipal Government Act.

2.0 Intent of this Document

The intent of the Leduc County Parks Design Standards is to assist Land Developer's Representatives and Consultants, Contractors, Land Developers and Leduc County Departments in meeting the planning, design, construction and maintenance requirements in parks and other open spaces in the County. These are to be considered minimum park development standards and will ensure consistency of development and conservation of open spaces as development projects move through conceptual planning, Master Plan approval, detailed design approval, construction approval, and ongoing maintenance through the two year warranty period.

Parks and open spaces include existing and future public outdoor recreation facilities within the County as well as vacant reserve lands that have the potential to provide recreation opportunities or environmental stewardship. Also included are Public Utility Lots (PUL's) which include Storm Water Management Facilities (SWMF) for the duration of this document. The following points should be taken into account when using this document:

- 1. All proposals and detailed designs shall be in compliance with statutory planning and development approvals as well as County bylaws and policies.
- 2. Where these standards refer to bylaws, acts, regulations and standards, this shall mean the most recent edition of amendments of the referenced document.
- 3. Where due to amendment of statutory requirements, conflicts or inconsistencies with these standards arise; the Landscape Architect shall refer the issue to the County for clarification or decision by the County.
- 4. Natural areas may be considered to become a part of the urban/rural park system.
- Any upland or wetland habitat disturbances are to be in accordance with the approved Municipal Development Plan (MDP), Area Structure Plan (ASP), Land Use Bylaw (LUB), latest version of Provincial and Federal Regulations, this document and required approved permits.
- 6. This document attempts to identify Leduc County's preference when there are alternative technical options available to address a particular open space development issue.
- 7. This document attempts to ensure the provision of locating and planning for Municipal Reserves (MR), Environmental Reserve (ER), and Conservation Easements (CE). This should be reflected in preliminary stages of ASP preparation, to ensure that the requirements for municipal reserve balance with total land dedication requirements.

3.0 How to Use Parks Design Standards

3.1 General

When required, all Land Developers and Leduc County will retain Landscape Architects who are members of the Alberta Association of Landscape Architects (AALA) as prime consultants for parks and open space development projects. Most often this will be at time of development but may be brought in sooner during the subdivision phase if appropriate.

The Landscape Architect may retain sub-consultants if necessary.

Geo-technical Engineers, who are members of the Association of Professional Engineers, Geologists, and Geophysicists of Alberta (APEGGA), will be required to recommend depth of piles for major signs, trail sub-base course, base course and surface course type and compaction requirements, and design & inspection for walls higher than 1.0 metre in height, and provide materials and compaction testing during construction.

Structural Engineers, who are members of APEGGA, will be required to design and inspect all pre-cast and poured-in-place concrete structures such as entrance walls and sign features.

Electrical Engineers, who are members of APEGGA, will be required to design and inspect all site lighting, scoreboard, public address sound systems, and other electrical installations.

The Landscape Architect may also require the services of hydrological engineers for storm water management and turf irrigation purposes, historic resource and risk assessment practitioners, wildlife biologists and arborists, and other "professionals" that might ensure the best plan and design solutions for the parks and open spaces.

3.2 Submission

The Landscape Architect will submit a conceptual plan for development or redevelopment for comment and approval by the County. Plans shall be submitted to Planning and Development (P&D) and will be referred out to other departments as necessary. The components of the park or open space will be based on the standards table presented as Table 1 in the Parks Design Standards section. The conceptual plan will also provide a site assessment of the existing natural and cultural resources and will prescribe the methods for protecting and managing those resources located within the parks and open space system. Should a Developer wish to exceed the standards outlined in this document, it is preferred that it be expressed at the conceptual planning stage.

The Landscape Architect will resubmit a Final Master Plan and Report for the project after direction is provided by the County. In the report the Landscape Architect will discuss how Crime Prevention Through Environmental Design (CPTED), Low Impact Development, Xeriscape Landscaping (Eco-Landscaping), and Fire Smart principles have been incorporated.

The Landscape Architect will submit construction drawings, specifications and cost estimates to P&D who will forward on to departments for approval prior to commencing construction. The approvals being applied for municipally, provincially, and federally should also be included in this package (e.g. Alberta Environment, Navigable Waters).

Any and all items not included in the Parks Design Standards such as boat docks and playground equipment to be included in the park development shall be identified and approved by Parks and Recreation (P&R) before installation. Suitable aluminum and floating docks may be supplied and installed by companies experienced with the products. Playground equipment may be supplied and installed by experienced and qualified companies. The submission for approval shall provide full details, specifications, and CSA certifications.

If the project is to be irrigated a detailed irrigation design with specifications prepared by a qualified irrigation designer will be required to be submitted for approval.

3.3 CONSTRUCTION COMPLETION CERTIFICATE/ FINAL ACCEPTANCE CERTIFICATE (CCC/FAC) PROCESS

In order for a development agreement to be drafted by Leduc County, amongst other items, a cost estimate for one hundred percent (100%) of construction costs for the whole development is required. For the landscaping component of these costs, the Developer shall submit, on the letterhead of a qualified Landscape Architect, the total amount of landscaping supplies, labour and maintenance for construction and the following two (2) year warranty period, including any Government Sales Tax. Prior to the start of construction, the Developer shall provide an irrevocable letter of credit for the full amount of security (100% of construction costs) specified in the endorsed development agreement. All parks and open space construction shall occur within the construction timeframe outlined in the endorsed development agreement.

When all construction has been complete, the Developer must request a Construction Completion Certificate (CCC) inspection by Leduc County. If the there are no deficiencies in the construction or landscaping, the County will issue the CCC and reduce the irrevocable letter of credit to fifteen percent (15%) of its original value. The fifteen percent (15%) will be retained by the County for a warranty/maintenance period of two (2) years. After this time period has expired, the Developer must request a Final Acceptance Certificate (FAC) inspection by the County. If no deficiencies are found, the County will issue the FAC and release the remaining amount of the irrevocable letter of credit, with the exception of any accumulated charge backs for work completed by the County. With the issuance of the FAC, the County then assumes the maintenance of infrastructure, parks and/or open space.

Landscape Architects will be responsible to provide copies of all construction materials testing reports, as-builts drawings in an Autocad format and maintenance logs during the two year warranty period.

Compaction tests of subgrade, sub-base, base course and asphalt surface, concrete surfaces, unit pavers surfaces will be taken at a minimum of one per every 1000 square metres of surface area.

Playground equipment inspection will be provided by a qualified representative of Leduc County. If any repairs are required during the warranty period then the Contractor and Developer will be required to make the repairs in a timely fashion. If these are not made to the satisfaction of the County, then the County will make them and charge back the costs including 10% administration costs.

The Landscape Architect will inspect the site with the Developer prior to CCC and FAC inspections. If the site is not ready and plant replacements and turf repairs have not been made then the site inspection will not be undertaken. If the Landscape Architect determines that the project is ready for inspection then the County will be asked in writing by the Landscape Architect to schedule an inspection.

If the project is a street tree and boulevard turf project only then the CCC can be requested at 90% completion to start the warranty time period to FAC. The project has to be completed to 100% before approval of FAC.

All turf areas, planting beds and pits, trails and playing surfaces are to be weed free; all tree stakes removed; and all mulch is to be topped up to specified depths prior to FAC approval. The cost of replacements resulting from theft, vandalism, carelessness, or neglect on the part of others, or any replacements caused due to circumstances beyond the control of the County shall be borne by the Contractor before the issuance of FAC.

All asphalt cracks and bird baths, all gravel dips and low spots, all playing surface irregularities are to be repaired prior to FAC issuance.

All discoloured paint, chips and rust spots shall be repaired to look like new prior to FAC issuance.

4.0 Landscape Architect's Responsibilities

It shall be the Landscape Architect's Responsibility to:

- 1. Meet with Leduc County's Planning and Development Services (P&D) at the conceptual stage of the design process to ensure that all parties have an understanding of the design elements, timing, County concerns, standards and confirm the level of public input prior to finalizing design.
- 2. Coordinate the preparation of all landscape designs in accordance with the architectural and engineering designs and reports including but not limited to: geotechnical, hydrological, civil, mechanical, electrical, structural and utility.
- Coordinate all base plan preparations with other Consultants to ensure utility, survey
 and base plan details are consistent with all other drawings forming part of the
 engineering drawing submission. Ensure utilities are located on landscape drawings,
 where feasible with regards to legibility.
- 4. Provide a tree clearing plan prior to tree clearing in accordance with this document.
- 5. Prepare all grading plans at time of subdivision for Municipal Reserve, Public Utility Lots, Open Space Plans, and Playground Sites. These shall be reviewed by P&D as well as other departments as necessary (i.e. Parks and Recreation (P&R), Public Works (PW), etc.).
- 6. Upon receipt of comments, re-submit revised drawings to Leduc County.
- 7. Coordinate a construction start up meeting with P&D, P&R, and PW prior to construction to ensure there is a clear understanding of the County's requirements, to establish a construction start date, agree on the progress schedule and subsequent inspection stages.
- 8. Inspect existing natural landscape features to be conserved, throughout development.
- 9. Approve plant material prior to installation. Joint inspection with County Staff is optional.
- 10. Submit written requests for substitution of plant materials to Leduc County for approval 1 month prior to planting substitution. The letter shall be addressed to P&D and will be referred out to P&R or Agricultural Services (AG) as required.
- 11. Ensure the contractor is responsible for the location of all underground utilities.
- 12. Ensure the applicable permits have been obtained including any municipal, provincial, or federal permits as necessary.
- 13. Ensure all playground equipment and installation is completed in accordance with this document and CSA standards.

- 14. Verify final grading and topsoil spreading and subsequent seeding and/or sodding are completed in accordance with this document. If grading differs from the original grading plans but is acceptable to Leduc County, a revised final grading plan shall be submitted.
- 15. Ensure plant material is installed properly, staked where required and is in a healthy, disease and pest free growing condition.
- 16. Ensure the protection of parks and open space development by installing barricades and/or fencing. Signs shall be erected as required for public safety. Security measures such as twenty-four hour on-site monitoring may be required at the discretion of the County.
- 17. Inspect all stages of Parks and Open Space Development; from construction through to the warranty/maintenance period in accordance with this document.
- 18. Be responsible for the coordination of all inspection documentation during the construction and maintenance periods in accordance with this document.
- 19. Verify that construction is complete prior to requesting a CCC inspection.
- 20. Ensure CCC/FAC process is followed in accordance with this document and County policy.

5.0 Parks Design Standards Table

The table below and continued on the following two pages outlines the minimum standards for parks and open spaces in the County and is applicable for developed and undeveloped areas. Items labeled as Discretionary will be dealt with on a case by case basis and decision as to whether they are required or not will be up to Leduc County.

DETAIL NUMBER	LEDUC COUNTY PARKS DESIGN STANDARDS R = Required, D = Discretionary N = Not Required Fencing Paige Wire Fence	S ROUND C PAR	ACHA CHACK PAK	A SUPLANT	NUIROUNINES!	WHEN POYE	OUT AN AL PLANT	NO SUPPLIED	MK KS D	D
1A	Paige Wire Fence	D	D	D	D	N	D	D	D	D
	Post & Double Rail Fence	D	D	D	D	N	D	D	D	D
1C	Chain Link Fence and Gate	D	D	D	D	N	D	D	D	D
	1850mm Wood Screen Fence and Gate	D	D	D	D	N	D	D	D	D
1E	1800-2500mm Noise Attenuation Fence	N	N	N	N	R	N	N	N	N
	Trails	R	R	D	R	N	D	D	D	D
2A	Shredded Bark Mulch Trail - 1500mm Wide	D	D	D	D	N	D	D	D	D
2B	Road Crushed Gravel Trail - 1500mm Wide	D	R	D	D	N	D	D	N	D
2C	Boardwalk Without Footing	D	D	D	D	N	D	D	D	D
	Asphalt Trail - 3000mm Wide	R	D	D	D	N	D	D	N	D
	Asphalt Trail Line Painting	R	D	D	D	N	D	D	N	D
	Trail Root Guard	D	D	D	D	N	D	D	N	D
	Trail Culvert	D	D	D	D	Ν	D	D	D	D
	Steel Pipe Bollard	D	D	D	D	Ν	D	D	D	D
	Steel T-Bollard	D	D	D	D	N	D	D	D	D
	Steel Pipe Access Gate	R	R	D	D	N	D	D	D	D
	Pressure Treated Timber Stairs	D	D	D	D	N	D	D	N	D
	Galvanized Steel Stairs	D	D	D	D	N	D	D	D	D
	Timber Retaining Wall - to 1000mm High	D	D	D	D	N	N	D	N	N
	Stacked Rock Retaining Wall - to 1000mm High	D	D	D	D	N	D	D	D	D
8	Haul-A-Way Waste Receptacle	R	R	R	R	N	D	D	N	D

	LEDUC COUNTY PARKS DESIGN STANDARDS R = Required D = Discretionary N = Not Required Portable Picnic Table Stationary Pedestal Picnic Table									
		公 人		10	1/2		OULAN COCA TO			
<u>س</u>		() ()	Z)	1		2.	OUT AL PLOCATION			
NUMBER		On,			V	(A)				
I	LEDUC COUNTY		(A)	Ø,			3/1	0		
	PARKS DESIGN STANDARDS			\ \&		X P.	100	10/2		
ETAIL	R = Required				(%)		(K)	S.		\
ET,	D = Discretionary	4	4	4		300	7/2/		<i>%</i> (0)	20
	N = Not Required	\(\frac{1}{12}\)	.0, /	\(\alpha\)	\0\	\ <u>\</u>	\(\sigma\)	<u>, 0</u> /	.0,/	0,
	Portable Picnic Table	D	D D	D	ח	N	N	D	IN	U
	•		R	D R	R R	N N		D R	N D	D D
	Backed Bench Fire Pit	R R	D	D	N	N	R N	D	N	N
	Tree Planting	R	R	R	R	D	R	R	R	R
	Shrub Planting	R	R	R	R	D	R	R	R	R
	Seeding and Sodding	R	R	R	R	R	R	R	R	R
100	Storm Water Management Facility (SWMF)	1	11	1 \	11	1 \	1	11	11	11
14	Planting	N	N	N	N	N	N	N	N	R
	Park Entrance Signs	R	R	D	D	N	D	D	D	D
	Park Signage	D	D	D	D	D	D	D	D	D
	Park Signage	D	D	D	D	D	D	D	D	D
	Park Interpretive Signs	R	R	D	N	N	D	D	D	D
	ER/MR Designation Signs	N	N	Ν	Ν	N	N	R	R	N
	Park Area Activity Signs	R	R	D	N	N	N	N	N	N
	Playgrounds	R	R	D	N	N	N	D	N	N
19A	Playground Edger	R	R	D	Ν	Ν	N	D	Ν	N
	Playground Signage	R	R	D	Ν	N	N	D	N	N
20A	Senior Soccer Field	D	D	D	N	N	N	D	N	N
20B	Intermediate Soccer Field	D	D	D	N	N	N	D	N	N
	Junior Soccer Field	D	D	D	N	N	N	D	Ν	N
	Goal Posts	D	D	D	Ν	N	N	D	N	N
	Goal Post - Permanent	D	D	D	N	N	Ν	D	N	N
20F	Goal Post w/ Sleeve	D	D	D	N	N	N	D	N	N

DETAIL NUMBER	LEDUC COUNTY PARKS DESIGN STANDARDS R = Required D = Discretionary N = Not Required Senior Baseball Diamond Little League Baseball Diamond	S NO NO CALLE	ACENT CALLS	E NE SUBDI PAR	NURO NICHER SOL	MINEN POND	SUL AN PHOLIS Z Z	10 Superior	N. C.S	200
21A	Senior Baseball Diamond	D	D	D	N	N	N			
	Little League Baseball Diamond	D	D	D	Ν	Ν	Ν			N
	Fastball/Slopitch Ball Diamond	ט	ט	ט	N	Ν	N	D	N	Ν
	Backstop Details	D	D	D	Ν	Ν	N	D	Ν	N
	Player's Bench	D	D	D	Ν	Ν	N	D	N	Ν
22	Outdoor Rink	D	D	D	Ν	Ν	N	D	N	N
	Sand Volleyball Court	D	D	D	Ν	Ν	N	D	Ν	Ν
	Horseshoe Pitch	D	D	D	Ν	Ν	N	D	N	N
25	Parking Lot Layout	R	D	D	D	N	N	N	N	Ν
	Campsite Layout and Surfacing	D	N	Ν	Ν	Ν	N	N	N	N
	Sewage Dump Station	D	Ν	Ν	Ν	Ν	Ν	Ν	Ν	Ν
	Seasonal Water Tap & Sump	D	N	Ν	N	Ν	N	Ν	N	N
	Fish Cleaning Stand	D	D	D	Ν	Ν	N	D	N	Ν
	Double Vault Toilet Building	R	R	D	Ν	Ν	N	D	N	N
31	Wildlife Viewing Platform	D	D	D	Ν	Ν	Ν	D	D	D

6.0 Parks and Open Space Construction

6.1 Site Protection, Preparation, Testing and Restoration

All parks and open space construction undertaken by Developers and the County by Landscape Contractors will provide the following during the construction period and subsequent maintenance periods should it be deemed necessary by the County.

- **6.1.1 Protection of Property and Underground Utilities:** provide protection, restore, and make good any damage to private and public property and underground services. A digital photo record of all existing damage to the site prior to construction is to be submitted to the County before commencement of any work on the site. Prior to commencement of work, confirm and establish the location and extent of underground utilities in the area. Notify the County and Utility Companies before excavating in the vicinity of utility lines.
- **6.1.2 Traffic Control:** All traffic and pedestrian control planning and procedures are to be submitted to the County for approval prior to commencement of construction.
- **6.1.3 Testing:** All testing of materials, compaction testing and all associated costs for testing are the responsibility of the Developers and/or their Contractors. The items requiring testing are to be identified in the construction drawings and specifications. Test results for the project proving all requirements have been met are to be submitted electronically to the County with the as-built drawings.
- **6.1.4 Survey:** During construction the Developer and/or their Contractor are responsible for all surveying of the project. An accurate log of control and survey work is to be maintained as the project progresses. The surveyor must be qualified and a current member of the Alberta Land Surveyors Association (ALSA). During construction the Surveyor must be prepared to submit documentation to verify accuracy of field engineering work should it be requested. On completion of the project a certificate is to be submitted by the Surveyor to certify that elevations and locations of completed work are in conformance or non-conformance with the construction drawings and specifications. In areas of non-conformance this certificate is to identify the areas and reasons for non-conformance. Final as-built drawings are to be submitted to the County within fourteen (14) days of completion of the work and before the Construction Completion Certificate approval.
- **6.1.5 Digital Photo Record:** A digital record is to be provided that has recorded the existing site conditions prior to construction, construction progress at minimum a weekly basis (minimum 10 photos per week), all components which are to be covered by other components including but not limited to: lengths and depths of cutting and demolition and removals, subgrade preparation, base course, reinforcing bars and ties, formwork, construction joints, tack coats, root pruning. A digital record is to be provided to record changes in weather, damage to components by others and any adverse site conditions. All photos to be complete with date and time stamp on the photo and are to be submitted to the County with the as-built drawings.

6.1.6 Security: The security of the site is the responsibility of the Developer and or their Contractor during construction. During critical periods, such as ensuring finished surfaces and line markings are not driven across or otherwise vandalized, manned site security is to be maintained.

6.2 Clearing and Grubbing

All areas requiring clearing are to be identified by flagging (do not use paint) the area and submitting a written request for approval to the County. Written approval from P&D with P&R recommendations must be received before commencement of any clearing.

The method of felling the trees shall be undertaken to occur within the clearing area as flagged. No trees shall be felled into adjacent treed areas. The stumps and underbrush within the clearing area shall be grubbed to remove all roots and debris greater than 50 mm in diameter. Burning of root and stump material will not be allowed. All roots and stump material is to be loaded, hauled and disposed off site at no expense to the County. All wood, appropriate for firewood, is to be cut, loaded, hauled and placed in a suitable pile as directed by the County. All branches may be loaded hauled and chipped in locations as directed by the County or disposed off site at no expense to the County. The preferred method of woody material disposal is to chip or mulch as much as deemed possible on site and then hauled to a location determined by the County.

6.3 Excavation and Embankment

Prior to any excavation work, a site survey is to be conducted and submitted to the County or their representative. If a project is Developer driven, a survey shall be undertaken, at no cost to the County, which will digitally record the condition of existing buildings, trees, other vegetation, lawns, fencing, service poles, wires, concrete, asphalt, survey bench marks and monuments located on the lands that may be impacted by the work. All existing buildings and surface features that may be negatively impacted by the work must be protected from damage while the work is in progress. Any damage resulting from the excavation shall be repaired by the Developer at no cost to the County. Where excavation necessitates root or branch cutting, approval by the County is required prior to work commencing. If works are to take place in proximity to watercourses or environmentally sensitive areas, provincial/federal policies and approvals must be followed and copies of such approvals forwarded to the County prior to construction.

6.3.1 Excavation: Advance notice must be provided to the County prior to excavation operations commencing. To prepare the site for excavation, remove obstructions including ice and snow from the surfaces to be excavated within the limits indicated. Cut hard surfaces neatly along limits of proposed excavation in order that surface may break evenly and cleanly. Excavate to designated cross-sections as indicated in approved construction drawings and specifications. Complete initial excavation from property line to property line, unless permitted otherwise by the County. Exercise caution to preserve bank stabilization where necessary and stage excavation to allow for related work. Do not disturb soil within branch spread or root spread of trees or shrubs that are to remain. If excavating through roots, excavate by hand and cut roots with a sharp axe or saw. Seal cuts with approved tree wound dressing immediately after cutting.

County approved excavated soil can be used to construct embankments, subgrade, berms, boulevard fill, trench backfill and for other purposes as directed by the County. Borrow excavation material obtained from off-site sources to only be used where there is insufficient suitable excavated material on the jobsite and only if approved by the County. In situations where excavation exposes unsuitable materials below the subgrade elevation and the County directs removal, excavate such materials as directed and make the bottom of the cut level with no loose materials. Where over-excavation occurs, restore grades by backfilling, compacting and regrading as directed by the County or their representative. If over-excavation is the result of the Contractor's error, no claim shall be made for the excess excavation and grade restoration. Remove and dispose of all surplus and unsuitable excavated material off site as directed by the County. The obstruction of flow of surface drainage or natural watercourses will not be permitted.

6.3.2 Fill: To prepare the site for fill, clear and grub the base of fill where necessary, remove topsoil and other unsuitable materials and scarify the base to ensure bond with fill material. Compaction of fill can best be achieved if the soil is dried or moistened to within +/-3% of optimum moisture content. Place and compact fill in hard surface areas by spreading fill material in successive horizontal lifts, each lift not to exceed 150 mm thickness when compacted. Compact each lift to the required density, as per the approved construction drawings and specifications, using suitable equipment. When constructing berms build the area by spreading layers of approved material not more than 300 mm thick and compacting each lift. Grade each layer using at least three (3) passes of the spreading equipment. For turf areas spread approved fill material in 150 mm lifts, compact and fine grade.

Stockpile fill materials in areas designated by the County. Stockpile granular materials in a manner that will prevent segregation. Native backfill material shall be free of all boulders larger than 200 mm in maximum dimension, roots, stumps or other debris that would prevent consolidation of the backfill when compacted. Any material found to have moisture content in excess of 5% over the plastic limit is not approved for backfill. All unsuitable backfill material is to be replaced with suitable select excavated material.

- **6.3.3 Side Slopes:** Trim slopes of cuts, fills and berms from top to bottom leaving the base of the slope neatly trimmed by removing lumps and loose material, or by blending loose material into the base. Finish slopes true to designated alignment, grade and shape.
- **6.3.4 Field Quality Control:** Check graded surfaces to ensure they meet a grade tolerance of +/-25 mm maximum variation from designated grade elevations and that crossfalls and bottoms of swales and ditches are graded to create positive flow. When tolerances are exceeded trim high areas to with tolerance and scarify low areas, backfill with approved material, compact to required density and regrade to within tolerance.

The compacted density requirements in the dry unit mass of sample at optimum moisture content as determined in the laboratory according to the American Society for Testing of Materials (ASTM) D698 Method A. The required density for fill under prepared and compacted subgrade for asphalt concrete paving, portland cement concrete paving, gravel structures, timber stairs and retaining walls and planted and turf areas is identified in the County Standard Construction Details and/or the approved construction drawings and specifications. Depending on the type of construction the

frequency of testing by a quality assurance laboratory, retained by the Contractor, is outlined in the approved construction drawings and specifications in accordance with ASTM D1556, ASTM D2167 or ASTM D2922 for comparison with a maximum density determined according to ASTM D698 Method A. If a density test result is less than the required density, that test result is discarded and 3 retests shall be performed on the area represented by the failed test. The average of the 3 retests shall represent the density of the area. If this average is less than the required density, the area shall be reworked to the full depth of the lift, the soil moisture altered as necessary and recompacted to the required density. If the area is not retested but is reworked and recompacted the area shall be tested at normal testing frequencies. If the failed lift is covered before the County has accepted the test results then the Contractor assumes the risk of uncovering and reworking the compacted lift.

6.3.5 Protection: All excavations are to be kept free of water while work is in progress. Protect open excavations against flooding and damage due to surface run-off. If the work areas floods, drain immediately by natural flow or by pumping into catch basins, manholes or ditches. All finished grades are to be protected from damage. with Repair and retesting shall be required by the County in the event that damage should occur. Erosion and sediment control to be provided to prevent migration of suspended sediments in downstream areas and erosion of on-site soils/sediments during the execution of the work.

6.4 Topsoil and Seeding

All disturbed and re-graded areas will be topsoiled with native topsoil and sodded or seeded with an appropriate seed mix (Detail 13B). Area to be utilized for neighbourhood parks and sports field areas will be mowed; all other areas will be considered native grass areas and will not be mowed after FAC. The minimum topsoil depth for sodding is 100 mm and for seeding is 150 mm. The subgrade will be compacted to 95% Standard Proctor Density and scarified to a minimum depth of 50 mm prior to topsoil spreading and preparation. All stones larger than 25 mm will be removed from the surface of the subgrade. The quality of the topsoil will be tested and submitted to the County for approval before construction. Approved topsoil will have 30% sand, 5% organic matter, neutral in pH and good erosion control. The County may require the topsoil be amended to make it more sandy and organic. Fertilizer will be required based on the soil analysis and shall be applied in accordance with the manufacturer's directions. The seedmix and seeding rate will be in accordance with detail 13B and submitted by the Landscape Architect to the County for approval.

6.5 Soilmix and Planting

The planting soilmix will be 2 parts approved topsoil, 1 part approved compost or peat moss, and one part approved horticultural medium coarse sand.

The planting requirements for private land of various land uses, roadways, and public utility lots are as prescribed in the land use by-law which will be revised from time to time.

The planting requirements for Parks and Open Spaces are 75 trees per hectare with shrubs being substituted at a rate of 5 shrubs to one tree. The minimum size of the plant material is as follows:

- deciduous tree minimum 50 mm caliper measured at 0.5 m (3 columnar aspen = 1 tree)
- coniferous tree minimum 1.8 m height with an overall average height of 2.4 m
- deciduous shrub minimum 400 mm height
- coniferous shrub minimum 400 mm height or spread

For Naturalization planting the planting area should consist of the following:

- 25% caliper stock that meets the requirements above
- 25% mix of shrubs
- 50% whips and cutting where live staking is permitted, minimum 10 per m².

6.6 Plant Materials

All plant material shall meet Horticultural Standards of Canadian Nursery Trades Association (CNTA) regarding grading, quality, and nomenclature or other standards where stated otherwise and approved by Leduc County. Plant material may be rejected should the roots be dried out, large branches broken, rootball broken/loosened or areas of bark torn.

Recommended and prohibited species for the purposes of landscaping are as follows. The following list is not exclusive. Other species may be approved by Leduc County for use in landscaping.

(a) Recommended Species – Deciduous trees:

American Mountain Ash - Sorbus americana

Amur Chokecherry - Prunus maackii

Bailey Select Schubert Chokeberry - Prunus virginiana 'Bailey Select"

Balsam Poplar – Populus balsamifera

Brandon Elm – Ulmus americana "Brandon"

Burr Oak - Quercus macropcarpa

Cutleaf Weeping Birch - Betula pendula Lanciniata

Dropmore Linden – Tilia x flavescens "Dropmore"

European Mountain Ash - Sorbus aucuparia

Goldrush Amur Chokecherry - Prunus maackii "Jefree"

Green Ash - Fraxinus pensylvanica lanceolata

Ivory Silk Tree Lilac - Syringa reticulate "Ivory Silk"

Ohio Buckeye - Aesculus glabra

Paper Birch – Betula papyrifera

Pink Spire Flowering Crabapple – Malus "Pink Spire"

Radiant Flowering Crabapple - Malus "Radiant"

Red Jade Flowering Crabapple – Malus "Red Jade"

Royal Beauty Flowering Crabapple – Malus "Royal Beauty"

Royalty Flowering Crabapple - Malus "Royalty"

Showy Mountain Ash - Sorbus decora

Silver Cloud Maple - Acer saccharinum

Snowbird Hawthorn - Crataegus mordensis "Snowbird"

Strathmore Flowering Crabapple - Malus "Strathmore"

Swedish Columnar Aspen – Populus tremula "Erecta"

Trembling Aspen - Populus tremuloides

Toba Hawthorn – Crataegus mordensis "Toba"

Thunderchild Flowering Crabapple – Malus "Thunderchild" Ventura Amur Maple – Acer X "Ventura"

(b) Recommended Species - Coniferous Trees

Colorado Spruce – Picea pungens Lodgepole Pine – Pinus contorta latifolia Norway Spruce – Picea Abies Siberian Larch – Larix Sibirica Scots Pine – Pinus Sylvestris White Spruce – Picea glauca

(c) Prohibited species

Baby's Breath – Gypsophilia panuculata Bladder campion - Silene cucubalus

Blueweed - Echium vulgare L.

Canada thistle - Cirsium zrvense L.

Cleavers - Galium zparine L. and Galium spurium

Common tansy - Tanacetum vulgare I.

Creeping Bellflower – Campanula rapunculoides

Cypress spurge - Euphorbia cyparissias I.

Dame's Rocket - Hesperis matronalis

Diffuse knapweed - Centaurea diffusa I.

Dodder - Cuscuta spp.

Eurasian Water Milfoil - Myriophyllum spicatum I.

Field bindweed - Convolvulus arvensis I.

Field scabious - Knautia arvensis (L.) duby

Himalayan Balsam – Impatiens glandulifera

Hoary cress - Cardaria spp.

Hound's-tongue - Cynoglossum officinale L.

Knawel - Scleranthus annuus L.

Leafy spurge - Euphorbia esula L.

Maltese Cross – Lychnis chalcedonica

Nodding thistle - Carduus nutans L.

Oxeye daisy - Chrysanthemum leucanthemum I.

Perennial sow thistle - Sonchus arvensis I.

Persian darnel - Lolium persicum

Purple Loosestrife - Lythrum aalicaria

Queen Anne's Lace - Daucus carota

Red bartsia - Odontites serotina I.

Russian knapweed - Centaurea repens I.

Russian Olive - Elaeagnus angustifolia

Salt-Cedar - Tamarix spp

Scentless Chamomile - Matricaria maritima I

Spotted knapweed - Centaurea maculosa I

Spreading dogbane - Apocynum androsaemifolium I.

Stork's bill - Erodium cicutarium I.

St.Johns Wort – Hypericum perforatum

Tall buttercup - Ranunculus acris I.

Teasel - Dipsacus fullonum

Toadflax - Linaria vulgaris
White Cockle - Lychnis alba
Wild Caraway – Carum carvi
Yellow Clematis – Clematis tangutica
Yellow star thistle - Centaurea solstitialis I.

6.7 Maintenance

The maintenance of plant material and mowed turf will be provided by the landscape contractor every week during the growing season from May 15 until October 15 and a log report identifying the tasks undertaken will be transmitted every week to the Landscape Architect and County as a record and confirmation that the maintenance has been undertaken. If soil conditions identify the need for fertilizers, plant material will be watered with a soluble fertilizer additive every two weeks and just prior to freeze-up to ensure vigorous growth. Plant material will also be pest controlled and pruned as required. Best practices will be used when applying fertilizer/pesticide and will not be used when in close proximity to water courses. Plant material will be inspected monthly for any damage however caused. Maintained turf, both sodded and seeded, will be mowed with litter pick-up weekly, fertilized three times per year, weed controlled twice per year, wear areas top dressed and over seeded and watered to maintain 100% turf coverage. Native seeded areas will be mowed with litter pick-up twice per year, fertilized if required three times per year, weed controlled twice per year, wear areas top dressed and over seeded and watered to maintain 100% turf coverage. If turf clippings during mowing are too moist or too deep then the Contractor will pick up and dispose of the clippings.

The maintenance of all other park components including but not limited to fencing, trails, site furnishings, and signs will be inspected and repaired on a monthly basis year round during the two year warranty period and a maintenance report identifying the tasks undertaken will be transmitted every month to the Landscape Architect and County as a record and confirmation that the maintenance has been undertaken.

Haul-a-way garbage receptacle emptying will be provided by the County starting at approval of the Construction Completion Certificate. When the Contractor is mowing, litter pick-up in all turf and planting bed areas will be provided by the Contractor before mowing.

If maintenance and repair is not being attended to then the County will undertake the maintenance and charge back the costs including and additional 10% administration cost.

6.7.1 Natural Area Maintenance

- As part of the maintenance reporting, identify and describe existing vegetation and site conditions to determine site specific goals and indicate best management strategies:
 - Prepare a site map
 - Vegetation and wildlife inventory (Rare or Endangered)
 - Non-native species and management

- Biodiversity
- Ecological Health
- Soil
- Microclimate
- In existing natural areas restore any disturbed areas to original condition.
- Where wetlands, stream courses and/or water bodies are part of the natural area, ensure erosion control measures are maintained until establishment of plant material and grasses.
- Use preventative measures against weed development. Non-native species management is required. Selective cutting, hand-pulling and spot spraying may be required.
- Coarse woody debris (downed wood, logs, stumps, branches and roots) are to be
 maintained in remnant tree stands. Management typically includes retention of
 existing coarse woody debris, introduction of new coarse woody debris (manual and
 natural methods), distribution and positioning of coarse woody debris, enhancement
 of coarse woody debris by cutting, shaping and companion planting. Stumps and
 roots should be retained on site. Consideration for the risk of fire hazard should also
 occur.
- Monitor Environmental Reserve areas to ensure function has not been impacted by Development. Where problems occur, restoration plans are to be approved by Leduc County prior to implementation.

7.0 Parks Design Standard Details


- 1A Paige Wire Fence
- 1B Post & Double Rail Fence
- 1C Chain Link Fence and Gate
- 1D 1850mm Wood Screen Fence and Gate
- 1E 1800-2500mm Noise Attenuation Fence
- 2A Shredded Bark Mulch Trail 1500mm Wide
- 2B Road Crushed Gravel Trail 1500mm Wide
- 2C Boardwalk Without Footing
- 2D Asphalt Trail 3000mm Wide
- 2E Asphalt Trial Line Painting
- 2F Trail Root Guard
- 2G Trail Culvert All Surfaces
- 3A Steel Pipe Bollard
- 3B Steel T-Bollard
- 4 Steel Pipe Access Gate
- 5 Pressure Treated Timber Stairs
- 6 Galvanized Steel Stairs
- 7A Timber Retaining Wall to 1000mm High
- 7B Stacked Rock Retaining Wall to 1000mm High
- 8 Haul-A-Way Waste Receptacle
- 9A Portable Picnic Table
- 9B Stationary Pedestal Picnic Table
- 10 Backed Bench
- 11 Fire Pit
- 12 Tree Planting
- 13A Shrub Planting
- 13B Seed and Sod Detail
- 14 Storm Water Management Facility (SWMF) Planting
- 15 Park Entrance Signs
- 16A Park Signage
- 16B Park Signage
- 17 Park Interpretive Signs
- 18 ER/MR and Campsite Designation Signs
- 19 Park Area Activity Signs
- 19A Playground Edger
- 19B Playground Signage
- 20A Senior Soccer Field
- 20B Intermediate Soccer Field
- 20C Junior Soccer Field
- 20D Goal Posts
- 20E Goal Post Permanent
- 20F Goal Post w/ Sleeve
- 21A Senior Baseball Diamond
- 21B Little League Baseball Diamond
- 21C Fastball/Slopitch Ball Diamond
- 21D Backstop Details
- 21E Player's Bench


- 22 Outdoor Rink
- 23 Sand Volleyball Court
- 24 Horseshoe Pitch
- 25 Parking Lot Layout
- 26 Campsite Layout and Surfacing
- 27 Sewage Dump Station
- 28 Seasonal Water Tap & Sump
- 29 Fish Cleaning Stand
- 30 Double Vault Toilet Building
- 31 Wildlife Viewing Platform

8.0 Parks Maintenance Standards Checklist

Table 2 Parks Maintenance Standards Checklist on this page indicates the requirements for maintaining the constructed parks and open spaces for the two year warranty period.

TABLE 2 PARKS MAINTENANCE STANDARDS CHECKLIST	Litter Pick-up	Lawn Turf Mowing	Native Seed Turf Mowing	Turf Fertilizing	Turf Weed Control	Water Turf As Required	Topdress & Overseed	Water Trees & Shrubs	Weed Beds & Tree Pits	Mulch Beds & Pits	Prune Trees & Shrubs	Trees & Shrubs Fertilizing	Inspect Trees & Shrubs	Gopher/Ground Squirrel Control
JANUARY FEBRUARY MARCH APRIL MAY 1-15 MAY WEEK 3 MAY WEEK 4 JUNE WEEK 1 JUNE WEEK 2 JUNE WEEK 4 JULY WEEK 1 JULY WEEK 2 JULY WEEK 3 JULY WEEK 3 JULY WEEK 4 AUGUST WEEK 2 AUGUST WEEK 3 AUGUST WEEK 4 SEPTEMBER WEEK 1 SEPTEMBER WEEK 1 SEPTEMBER WEEK 2 SEPTEMBER WEEK 3 SEPTEMBER WEEK 4 OCTOBER WEEK 1 OCTOBER WEEK 2 NOVEMBER DECEMBER	1 1 TOTAL	27	16	2	2	2	0	1	11	3	1	2	3	6	2

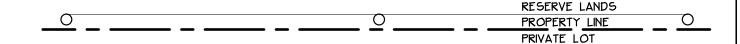

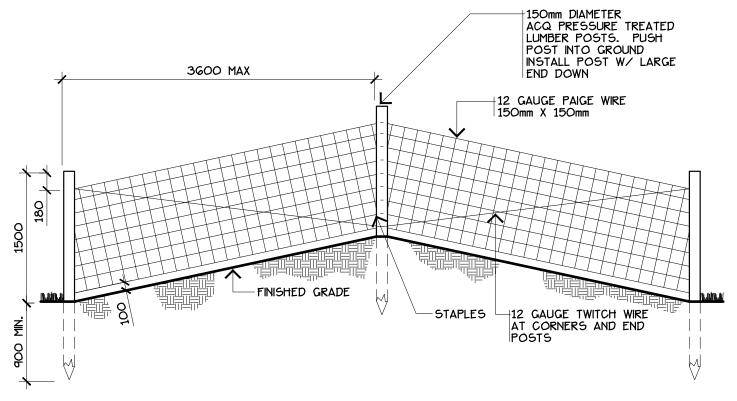


NOTES:

- ·FIELD TREAT ALL CUT ENDS AND DRILLED HOLES W/ 2 COATS OF CLEAR ACQ.
- ·ALL HARDWARE TO BE GALVANIZED
- *ALL TREES. BRUSH AND OTHER OBSTACLES WHICH INTERFERE WITH THE CONSTRUCTION AND ALIGNMENT OF THE FENCE TO BE REMOVED PRIOR TO CONSTRUCTION OF THE FENCE
- ·GATES TO BE SHOWN ON A PLAN AND LOCATED ACCORDINGLY OR AS DIRECTED BY THE CONSULTANT


ELEVATION

PAIGE WIRE FENCE DRAWING: DRAWING NO. REVISION NO: DATE: 2009 08 EARTHSCAPE CONSULTANTS NTS LEDUC DRAWN BY: SCALE: COUNTY 1A CHECKED: N.M. D.O. APPROVED: LEDUC COUNTY PARKS AND RECREATION SUITE 101, 1101 - 5th STREET, NISKU, ALBERTA, T9E 2X3

RESERVE LAND IMPROVED FENCE IN HIGH VISIBILITY LOCATIONS

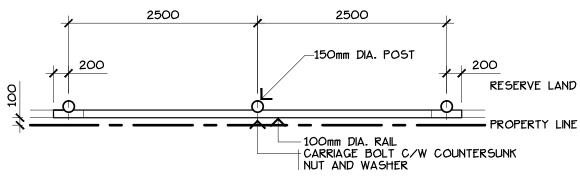

PLAN VIEW

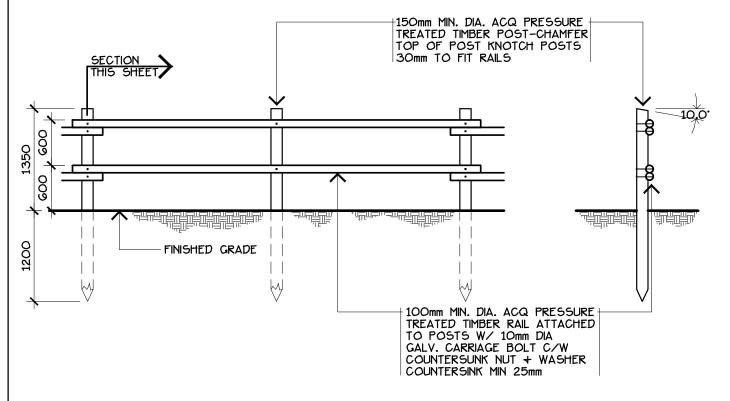

NOTES:

•PUSH POSTS INTO GROUND MIN. 1200mm.

*FIELD TREAT ALL CUT ENDS AND DRILLED HOLES W/ 2 COATS OF CLEAR ACQ.

ELEVATION


SECTION

DRAWING: POST & DOUBLE RAIL FENCE

	REVISION NO:			DATE:	2009 08	
LEDUC	DRAWN BY:	EARTHSCAPE CON	SULTANTS	SCALE:	1:50	
COUNTY	CHECKED:	N.M.		APPROVED:	D.O.	
LEDUC COUNTY F	PARKS AN	ND RECREATION	SUITE 101, 1101	- 5th STREET.	NISKU, ALBERTA, T9E 2X3	\Box

1B-1

DRAWING NO.

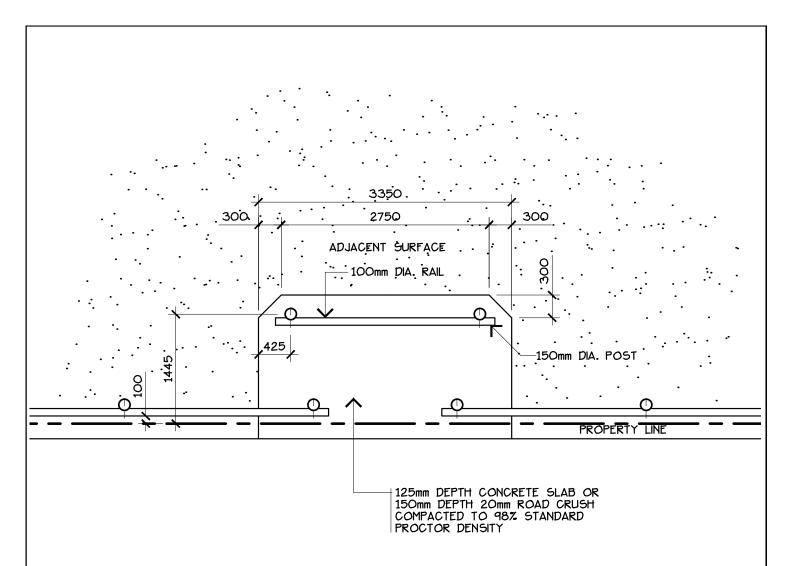

NOTES:

•CONCRETE SLAB:

CONCRETE SLAD:

CONCRETE - CLASS C. TYPE GU. 30MPa • 28 DAYS. SLUMP 50-70. AIR ENTRAINED

>5.5%. MAXIMUM 20mm AGGREGATE. MAXIMUM WATER 0.45. CEMENT 335kg/m3

BROOM FINISH SURFACE. EDGES TOOLED. 50mm TOOLED JOINTS MAXIMUM 3000mm O.C.

REINFORCING WELDED STEEL WIRE FABRIC 152X152 MW9.9/9.1

50mm DEPTH LEVELLING SAND

150mm DEPTH COMPACTED SUBGRADE TO 98% STANDARD PROCTOR DENSITY


PLAN VIEW


DRAWING:	POST & DOUBLE RAIL FENCE PEDESTRIAN ACCESS

	REVISION NO:		DATE:	2009 08					
L E D U C COUNTY	DRAWN BY:	EARTHSCAPE CONSULTANTS	SCALE:	1:50					
COUNTY	CHECKED:	N.M.	APPROVED:	D.O.					
EDUC COUNTY DARKS AND DECREATION									

1B-2

DRAWING NO.

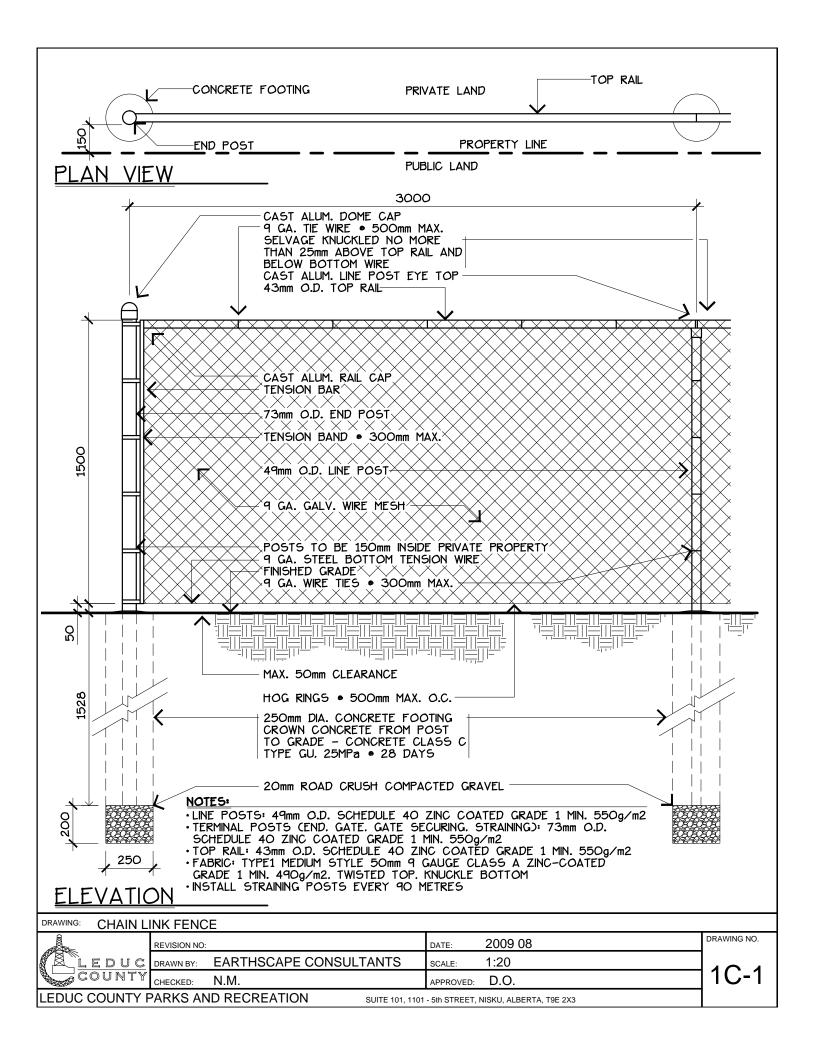

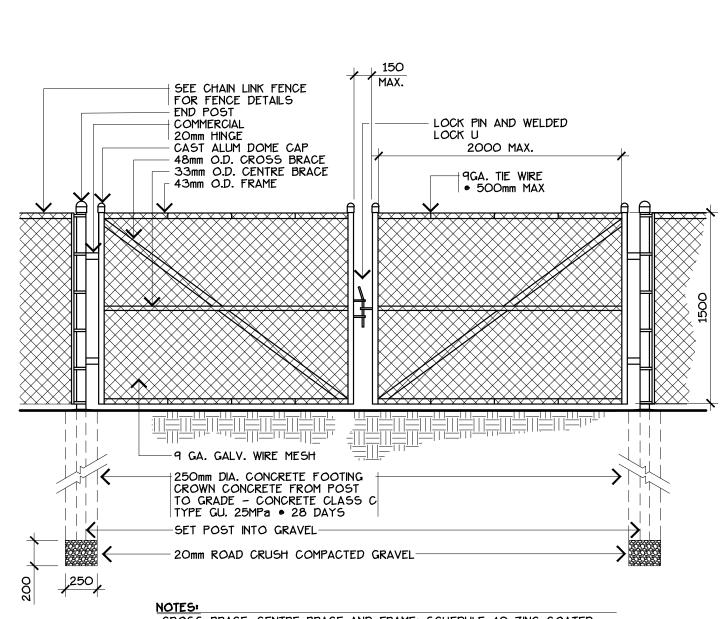


· CROSS BRACE. CENTRE BRACE AND FRAME: SCHEDULE 40 ZINC COATED GRADE 1 MIN. 550g/m2

• TERMINAL POSTS (END. GATE, GATE SECURING, STRAINING): 73mm O.D. SCHEDULE 40 ZINC COATED GRADE 1 MIN. 550g/m2
• FABRIC: TYPE1 MEDIUM STYLE 50mm 9 GAUGE CLASS A ZINC-COATED GRADE 1 MIN. 490g/m2. TWISTED TOP. KNUCKLE BOTTOM

ELEVATION

DRAWING: CHAIN L	INK FENC	E GATE					
	REVISION NO:			DATE:	2009 08		DRAWING NO.
LEDUC COUNTY	DRAWN BY: EARTHSCAPE CONSUL		SULTANTS	SCALE:	NTS		400
COUNTY	CHECKED:	N.M.		APPROVED:	D.O.		1 C-2
LEDUC COUNTY F	PARKS AN	ID RECREATION	SUITE 101, 1101	- 5th STREET,	NISKU, ALBERTA, T9E 2X3		

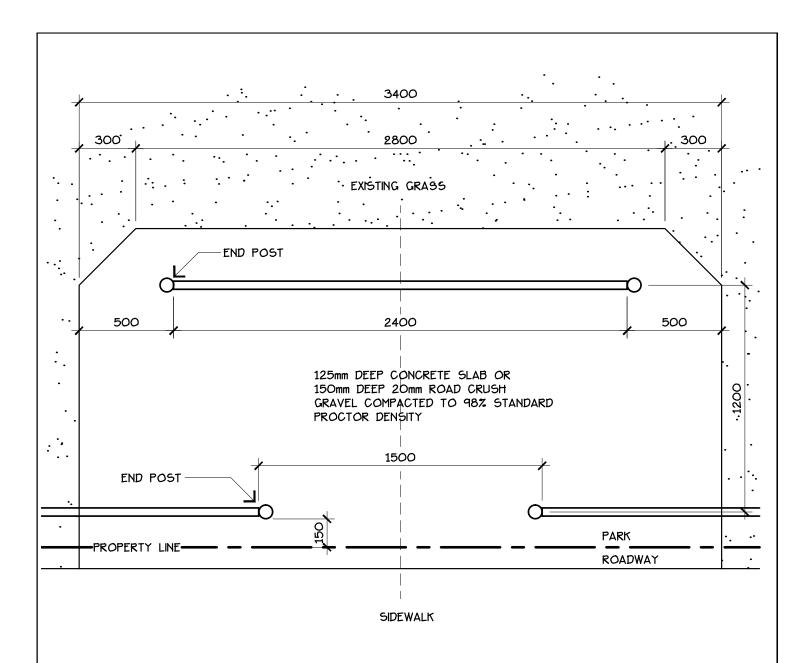

NOTES:


•CONCRETE SLAB:

CONCRETE - CLASS C. TYPE GU. 30MPa • 28 DAYS. SLUMP 50-70. AIR ENTRAINED >5.5%. MAXIMUM 20mm AGGREGATE. MAXIMUM WATER 0.45. CEMENT 335kg/m3 BROOM FINISH SURFACE. EDGES TOOLED. 50mm TOOLED JOINTS MAXIMUM 3000mm O.C. REINFORCING WELDED STEEL WIRE FABRIC 150x150xG. 50mm DEPTH LEVELLING SAND 150mm DEPTH COMPACTED SUBGRADE TO 98% STANDARD PROCTOR DENSITY


PLAN VIEW


DRAWING NO.	ATE: 2009 08	DATE:):	REVISION NO:	
\Box	cale: 1:20	SCALE:	EARTHSCAPE CONSULTANTS	DRAWN BY: EARTHSCAPE	
10-3	PPROVED: D.O.	APPROVED:	N.M.	CHECKED: N.M.	
	th STREET, NISKU, ALBERTA, T9E 2X3	- 5th STREET, N	ND RECREATION SUITE 101, 1101		


RESIDENTIAL PROPERTY AND RESERVE LAND 2440 -38x140 STRINGER +25x150 FENCE BOARDS |TIGHT SPACING PRIVATE LAND -PROPERTY LINE-25x100 FASCIA BOARD 150x150 POST RESERVE LAND CONCRETE PILE PLAN VIEW SECTION SHEET 1D-2 38x89 MID STRINGER --150x150 POST 25x100 FASCIA BOARD 38x140 STRINGER 25x15O FENCE BOARDS 25x100 FASCIA BOARD-38x140 STRINGER FINISHED GRADE CONCRETE PILE **ELEVATION** 1850mm WOOD SCREEN FENCE - PLAN VIEW & ELEVATION DRAWING: DRAWING NO. REVISION NO: DATE: 2009 08 DRAWN BY: **EARTHSCAPE CONSULTANTS** EDUC 1:20 SCALE: ID-1 COUNTY N.M. CHECKED: D.O. APPROVED: LEDUC COUNTY PARKS AND RECREATION SUITE 101, 1101 - 5th STREET, NISKU, ALBERTA, T9E 2X3

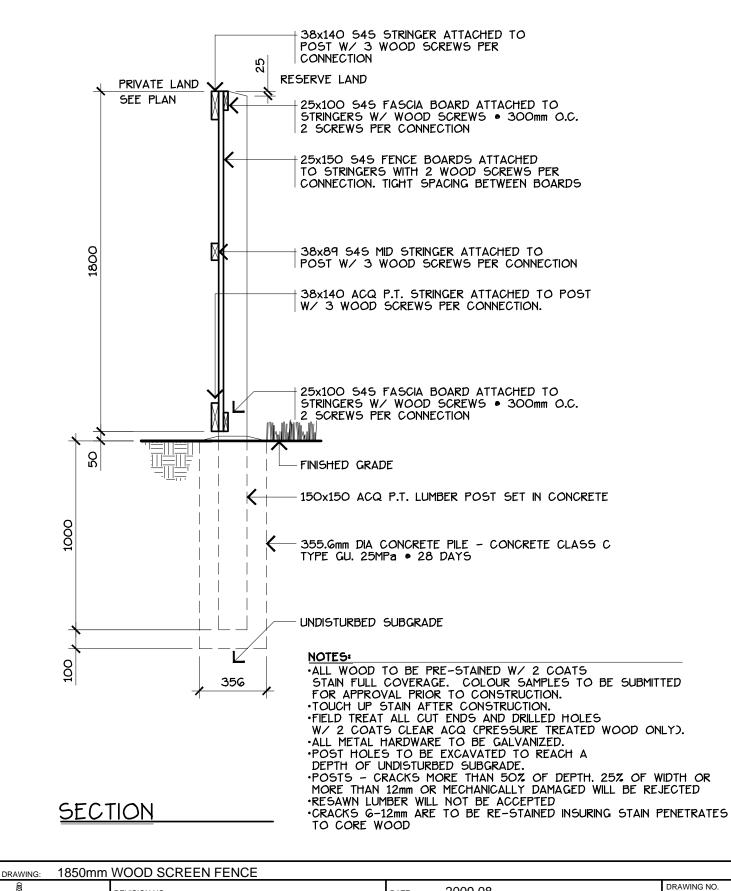



DRAWING. 1000111111	1100D 0	OILEIVI LIVOL				
	REVISION NO:			DATE:	2009 08	DRAWING NO.
LEDUC	DRAWN BY:	EARTHSCAPE CON	ISULTANTS	SCALE:	1:20	ID 0
COUNTY	CHECKED:	N.M.		APPROVED:	D.O.	ID-2
LEDUC COUNTY F	PARKS AN	ID RECREATION	SUITE 101, 1101	- 5th STREET, I	NISKU, ALBERTA, T9E 2X3	

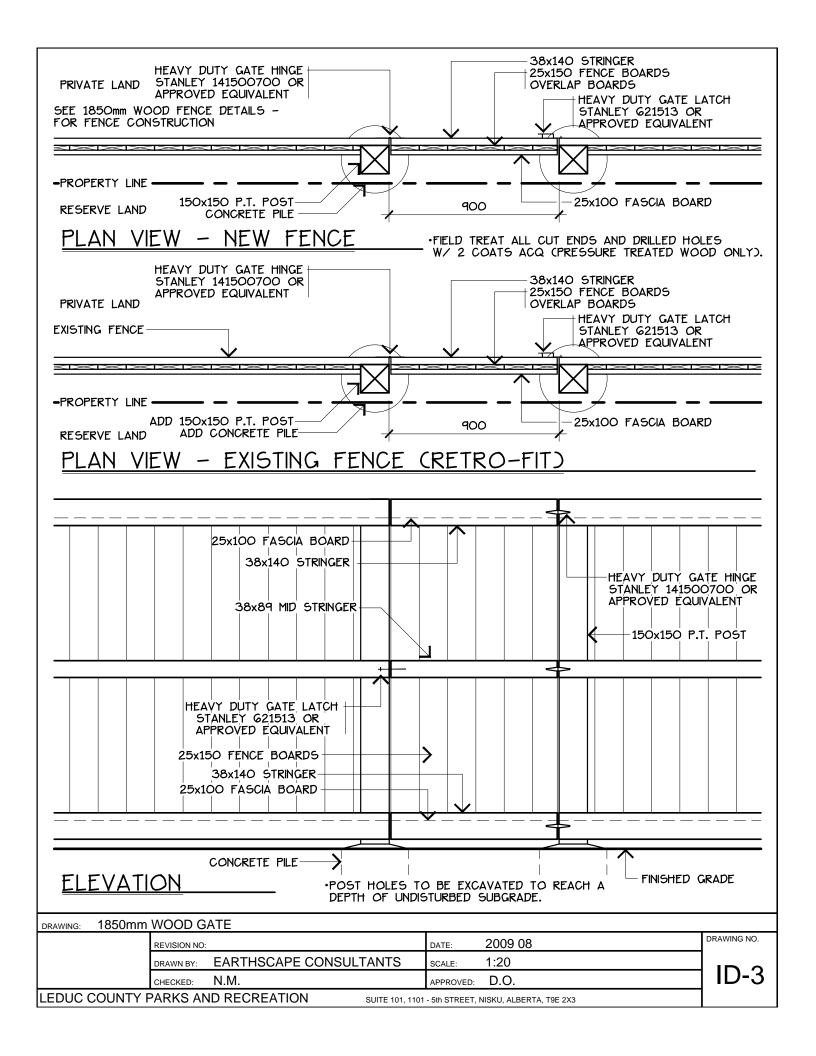

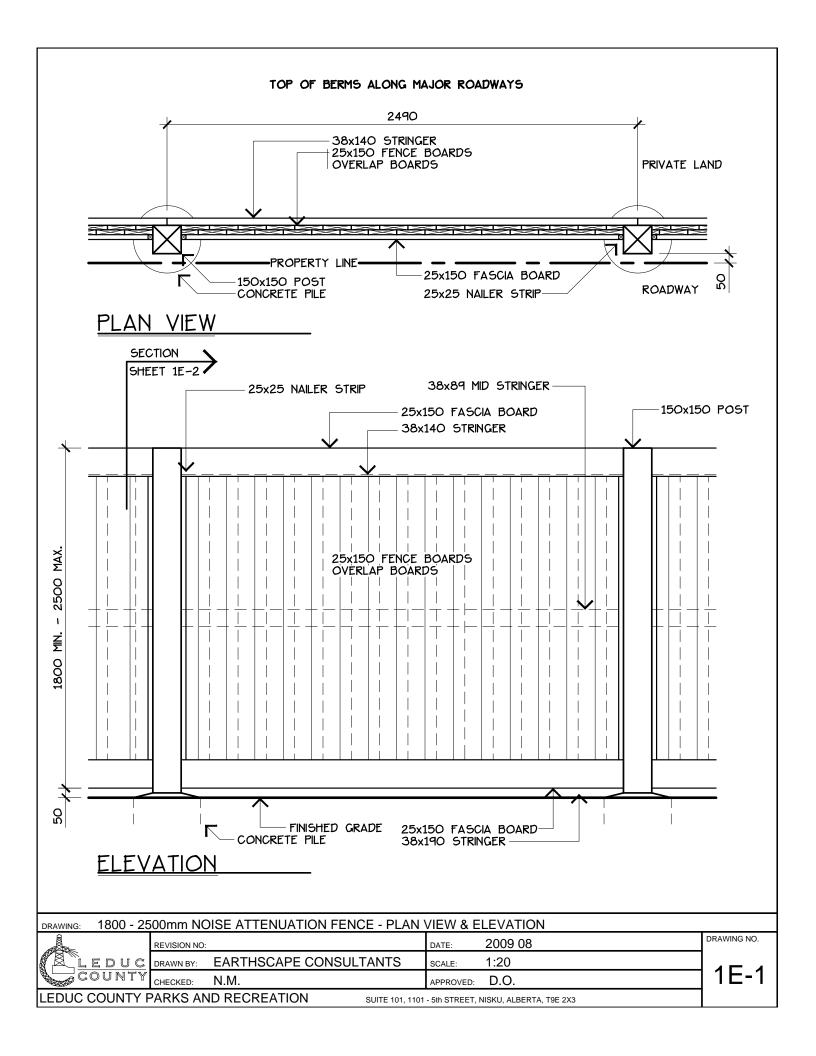

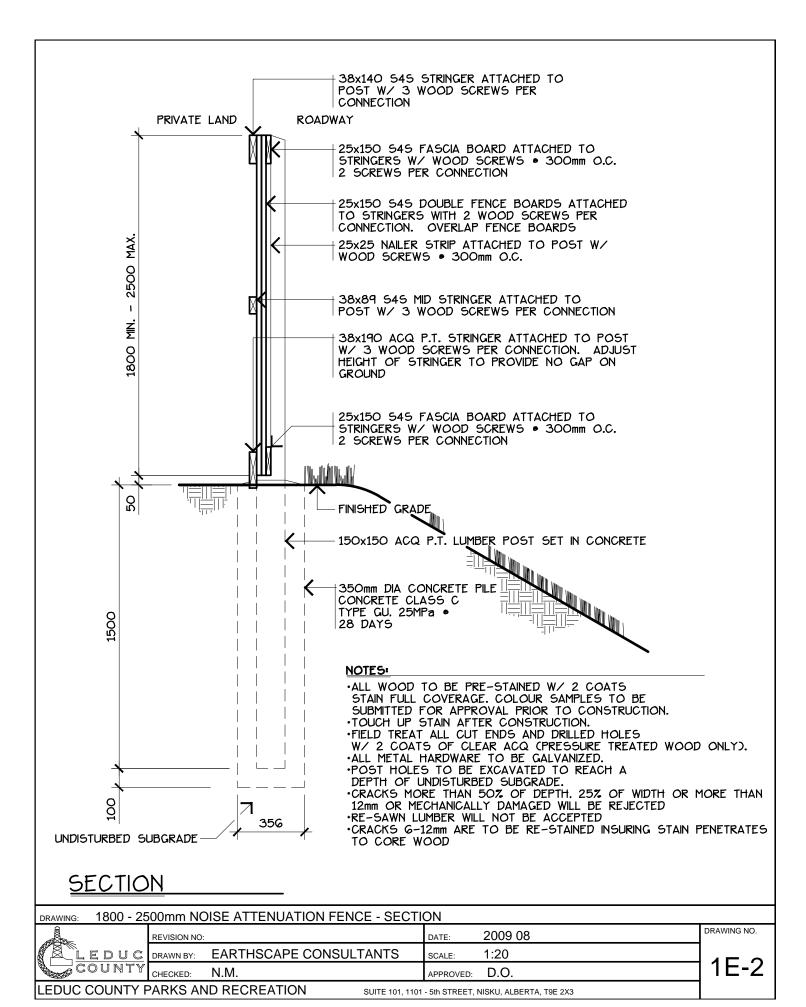

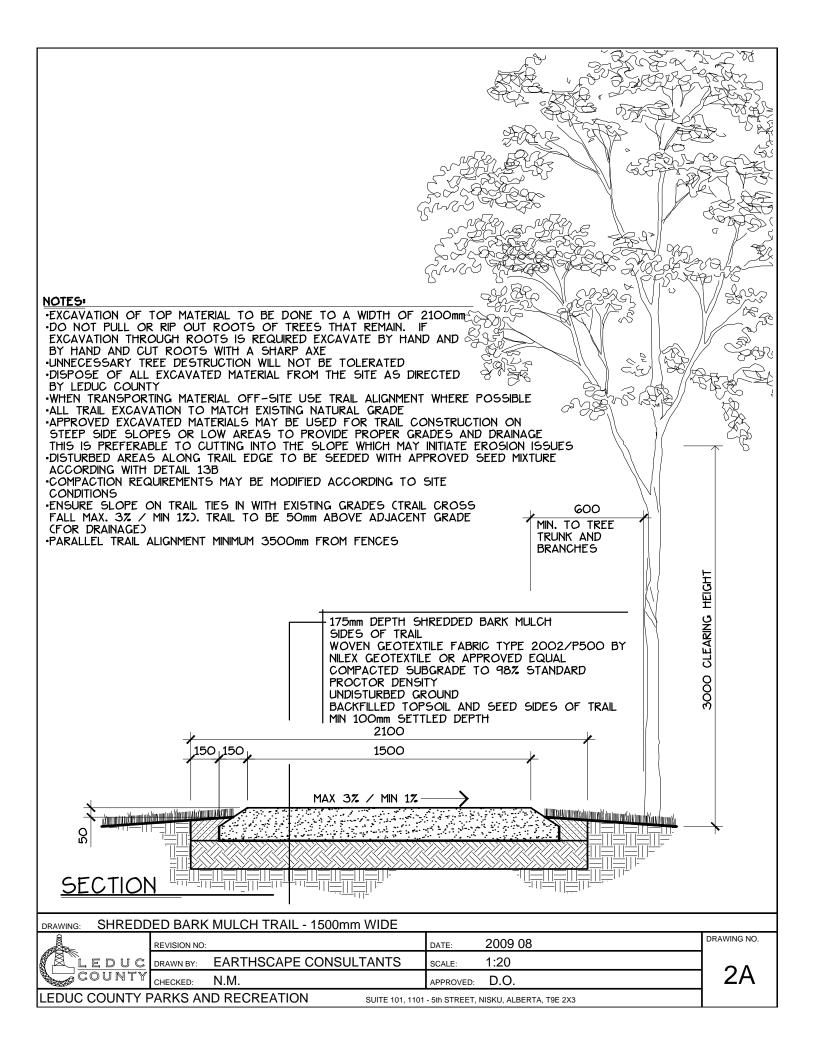

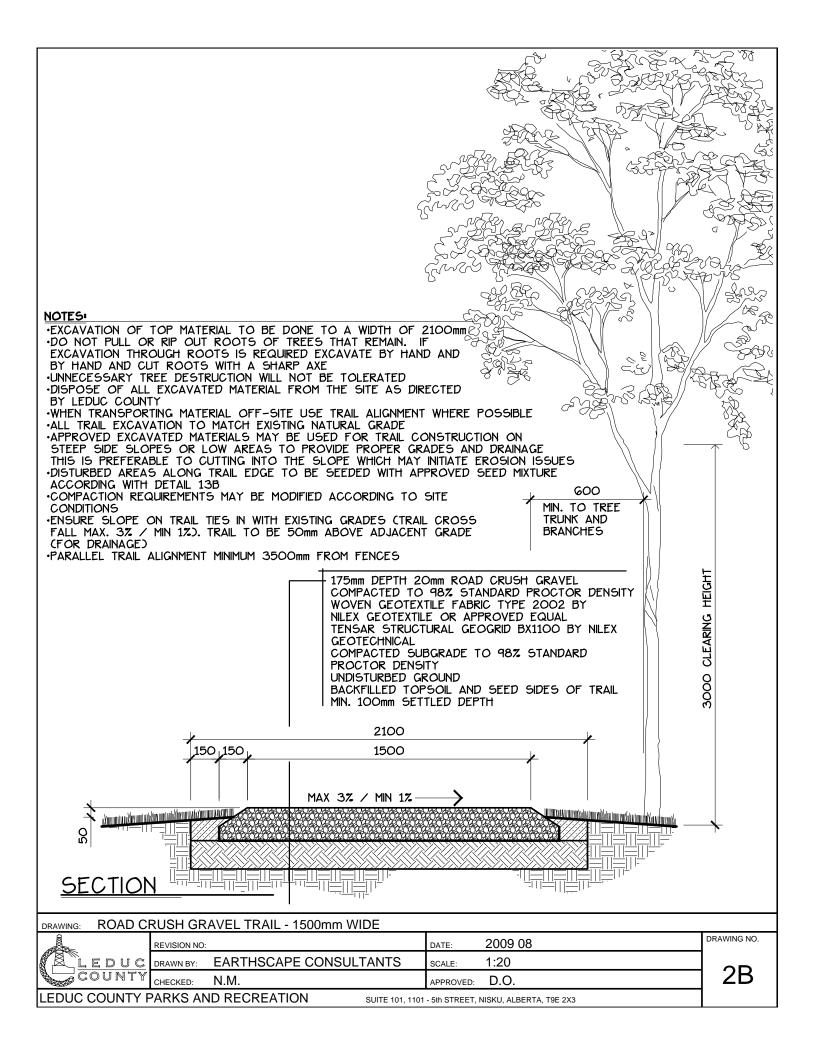

AREAS TOO WET FOR SHREDDED BARK MULCH OR GRAVEL TRAIL 50x178 HEADER 50x150 DECKING W/ 12mm SPACING 50x150 SIDE EDGER SECTION A SHEET 2C-2 2400 FINISHED TRAIL SURFACE 150x200 TIMBER GROUND BEAM

NOTES:

- *AREAS TOO WET FOR SHREDDED BARK MULCH TRAIL OR GRAVEL TRAIL ALL WOOD TO BE ALLOWED TO WEATHER.

 *FIELD TREAT ALL CUT ENDS AND DRILLED HOLES W/ 2 COATS CLEAR ACQ (PRESSURE TREATED WOOD ONLY).

 *ALL METAL HARDWARE TO BE GALVANIZED.


PLAN VIEW

BOARDWALK WITHOUT FOOTING - PLAN VIEW DRAWING: DRAWING NO. REVISION NO: DATE: 2009 08 EDUC **EARTHSCAPE CONSULTANTS** 1:20 DRAWN BY: SCALE: COUNTY CHECKED: N.M. D.O. APPROVED:


LEDUC COUNTY PARKS AND RECREATION

SUITE 101, 1101 - 5th STREET, NISKU, ALBERTA, T9E 2X3


2C-1

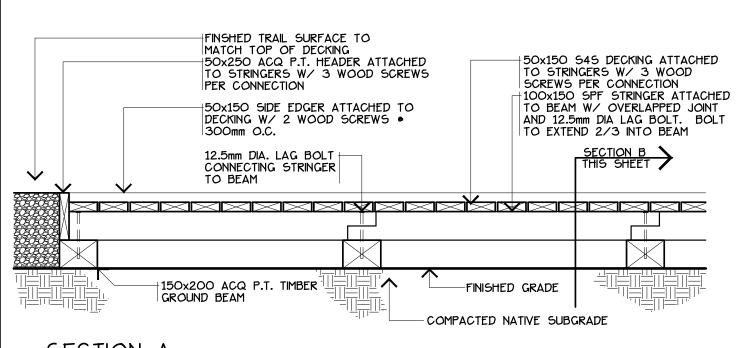

SECTION A

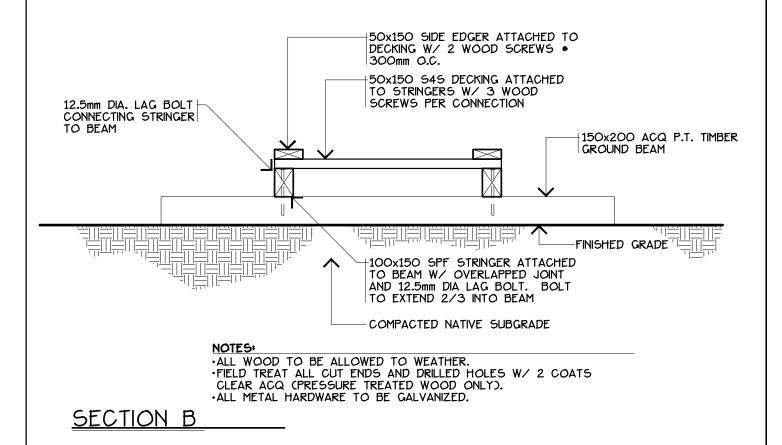



BOARDWALK WITHOUT FOOTING - SECTION DRAWING:

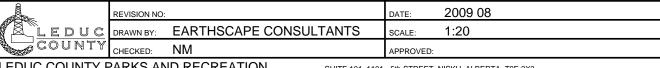


LEDUC COUNTY PARKS AND RECREATION SUITE 101, 1101 - 5th STREET, NISKU, ALBERTA, T9E 2X3 2C-2

DRAWING NO.

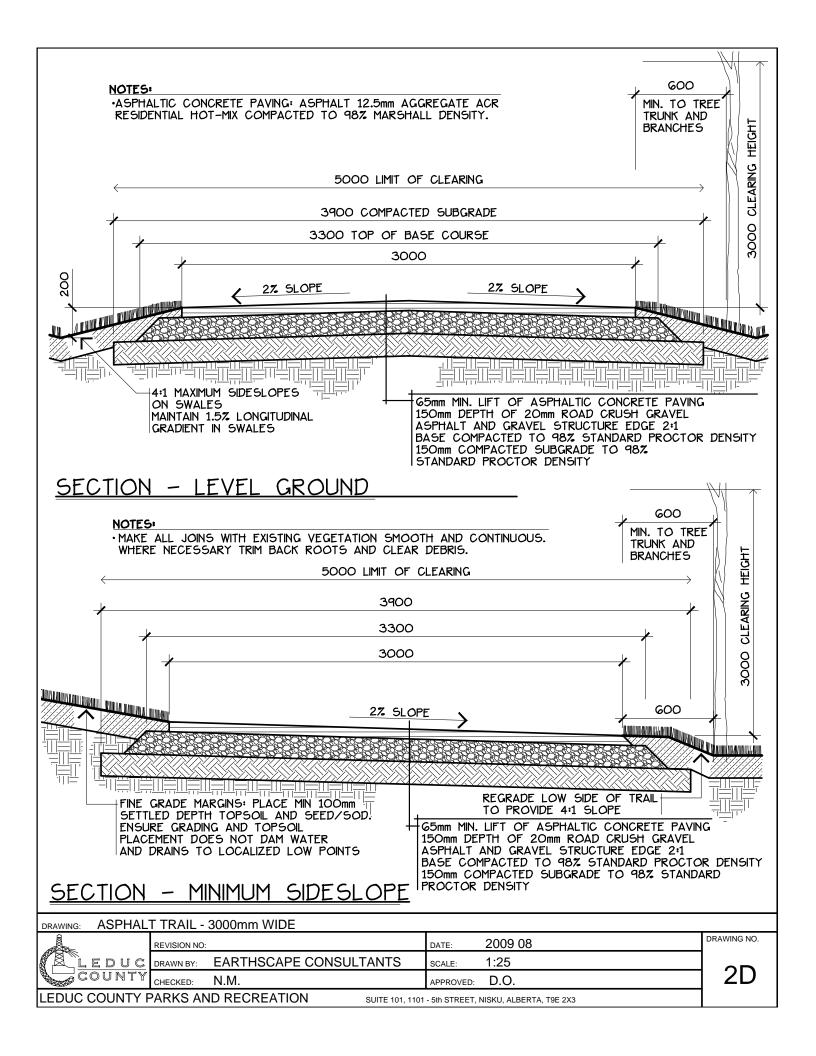


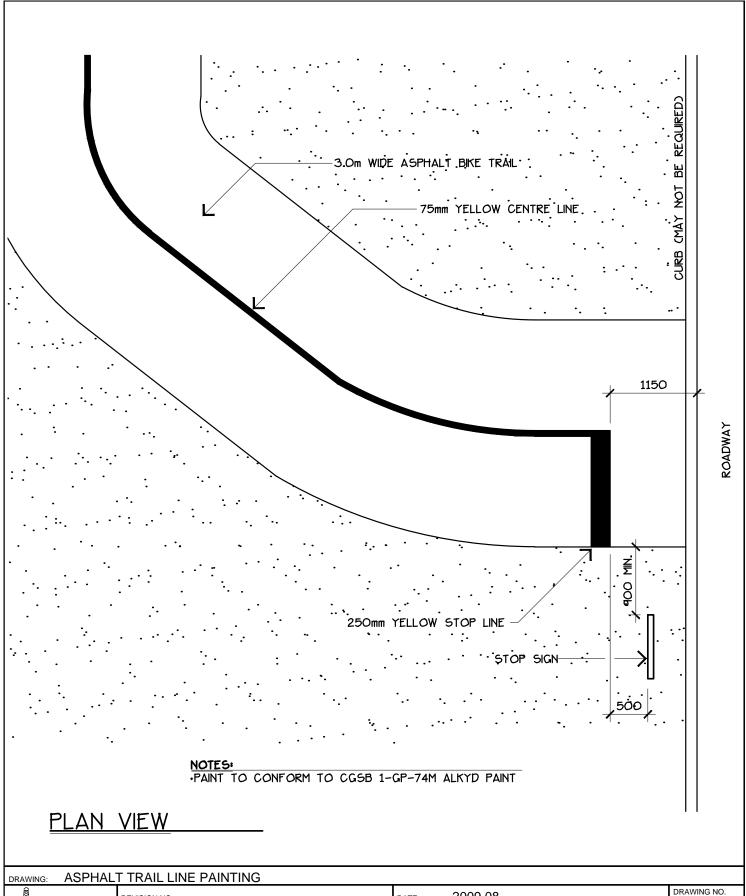

DRAWING: ASPHAL	IIKAILL	INE PAINTING				
O CONTRACTOR OF THE CONTRACTOR	REVISION NO:			DATE:	2009 08	DRAWING NO.
		EARTHSCAPE CC	NSULTANTS	SCALE:	1:50	
COUNTY	CHECKED:	N.M.		APPROVED:	D.O.] 2E
LEDUC COUNTY F	PARKS AN	ID RECREATION	SUITE 101, 1101	- 5th STREET,	NISKU, ALBERTA, T9E 2X3	

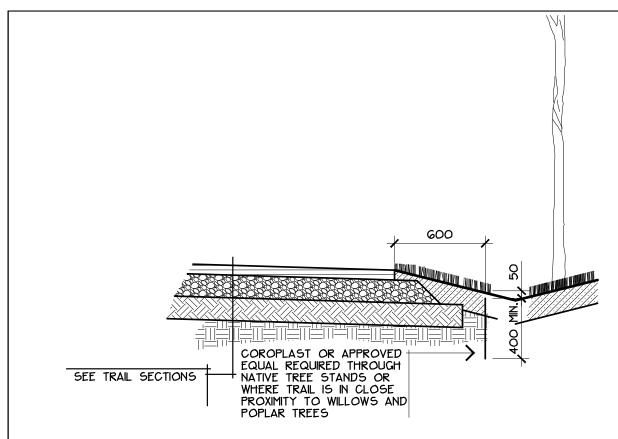


TRAIL SECTION

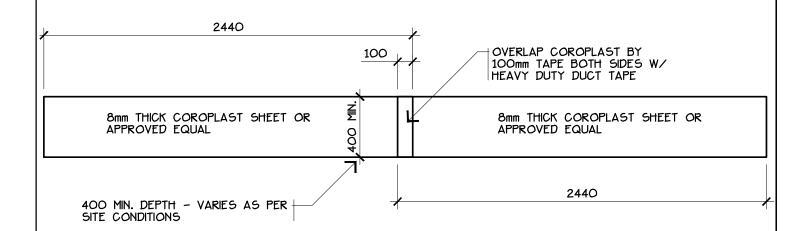


ELEVATION

DRAWING:	TRAII	ROOT	GUARD
DRAWING.			

	REVISION NO:			DATE:	2009 08	DRAWING NO.
LEDUC	DRAWN BY:	EARTHSCAPE CO	NSULTANTS	SCALE:	1:25	
COUNTY	CHECKED:	N.M.		APPROVED:	D.O.] 2F
LEDUC COUNTY I	PARKS AN	ND RECREATION	SUITE 101, 1101	- 5th STREET, I	NISKU, ALBERTA, T9E 2X3	

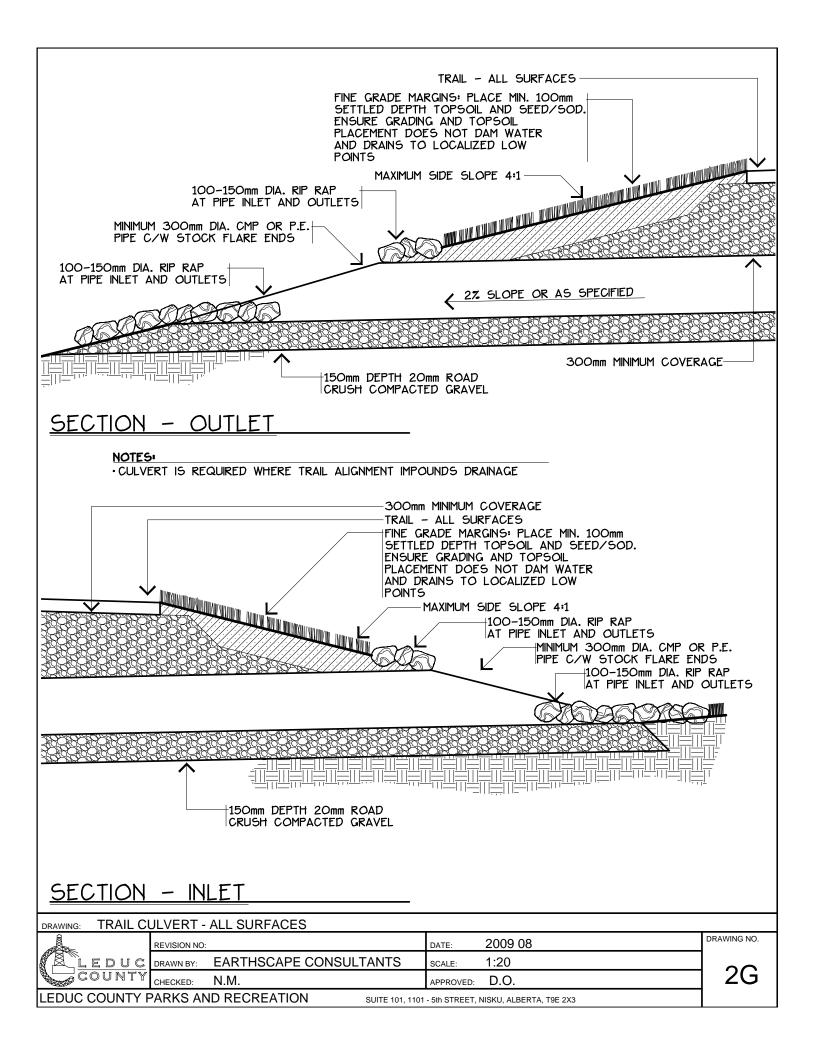

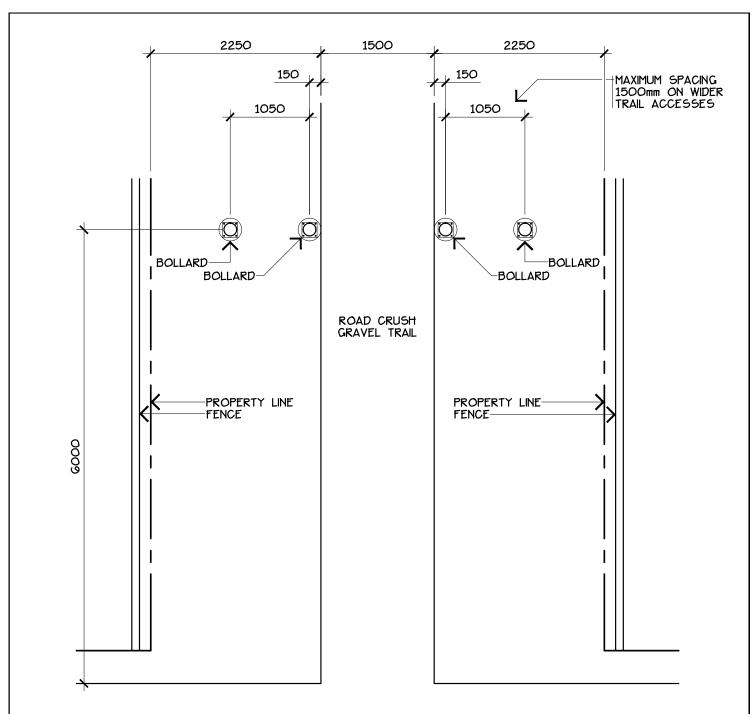

- *FOOTING LOCATIONS MAY VARY BASED ON TRAIL TYPE AND WIDTH
- •ALL EXPOSED METAL SURFACES TO BE POWDER COATED TO COUNTY COLOUR PANTONE BLUE-301C
 •PROVIDE KEY LOCK ON BOLLARDS ALL LOCKS KEYED TO COUNTY MASTER

- *ALL WELDS TO BE FILLET WELDS AND GROUND SMOOTH *ALL BOLTS. CHAINS. NUTS + WASHERS TO BE GALVANIZED *BOLLARDS AND COLLARS TO HAVE A Gmm STEEL
- **THICKNESS**


SITE PLAN

STEEL PIPE BOLLARD DRAWING:

	REVISION NO:			DATE:	2009 08		
LEDUC COUNTY	DRAWN BY:	EARTHSCAPE CONSUL	TANTS	SCALE:	1:50		
COUNTY	CHECKED:	N.M.		APPROVED:	D.O.		
LEDUC COUNTY PARKS AND RECREATION SUITE 101 1101 - 5th STREET, NISKU, ALBERTA, 196 2X3							


3A-1

DRAWING NO.

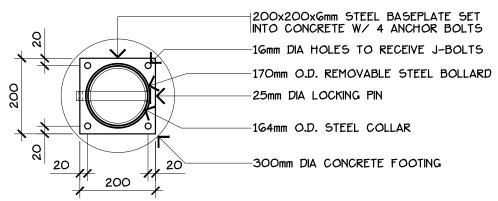

·PROVIDE KEY LOCK ON BOLLARDS - ALL LOCKS KEYED TO COUNTY MASTER


PLAN VIEW

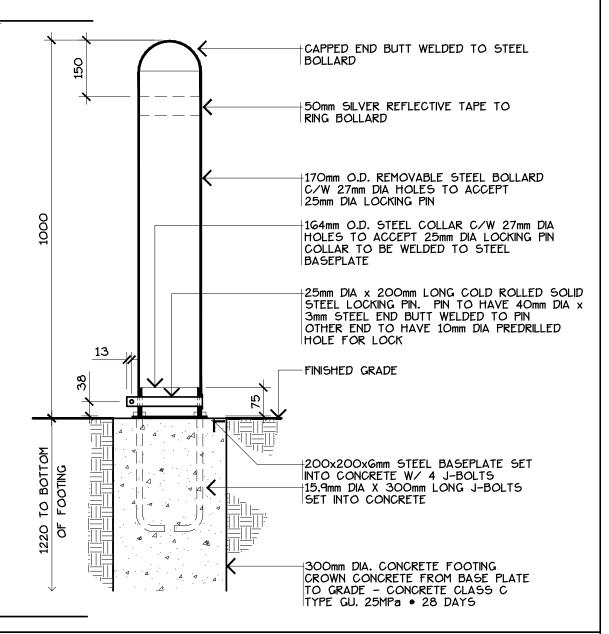


DRAWING: STEEL PIPE BOLLARD

SECTION

	REVISION NO:			DATE:	2009 08	DRAWING NO.
LEDUC	DRAWN BY:	EARTHSCAPE CON	SULTANTS	SCALE:	1:10	040
COUNTY	CHECKED:	N.M.		APPROVED:	D.O.	3A-2
LEDUC COUNTY F	PARKS AN	ID RECREATION	SUITE 101 1101	- 5th STREET I	NISKII ALBERTA TOE 2X3	

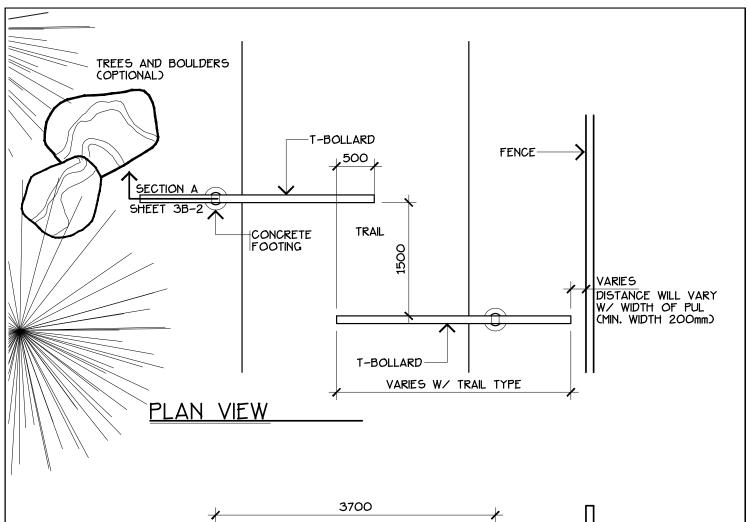

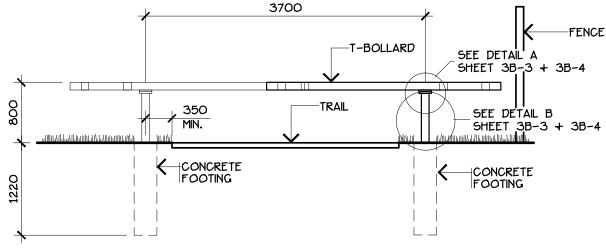


NOTES:


·ENSURE THAT BOLLARD ARMS ARE EVEN WITH EXISTING FENCE STRUCTURES

- *FOOTING LOCATIONS MAY VARY BASED ON TRAIL TYPE
- ·ALL EXPOSED METAL SURFACES TO BE POWDER COATED · PROVIDE KEY LOCK ON BOLLARDS ALL LOCKS TO COUNTY COLOUR PANTONE BLUE-301C
- *ALL WELDS TO BE FILLET WELDS AND GROUND SMOOTH *ALL BOLTS, CHAINS, NUTS + WASHERS TO BE GALVANIZED *POSTS AND BOLLARD ARMS TO HAVE MIN. 5mm STEEL
- **THICKNESS** KEYED TO COUNTY MASTER


ELEVATION


STEEL T-BOLLARD DRAWING: DRAWING NO. REVISION NO: DATE: 2009 08 **EARTHSCAPE CONSULTANTS** 1:50 LEDUC DRAWN BY: SCALE: 3B-1 COUNTY N.M. CHECKED: D.O. APPROVED: LEDUC COUNTY PARKS AND RECREATION SUITE 101, 1101 - 5th STREET, NISKU, ALBERTA, T9E 2X3

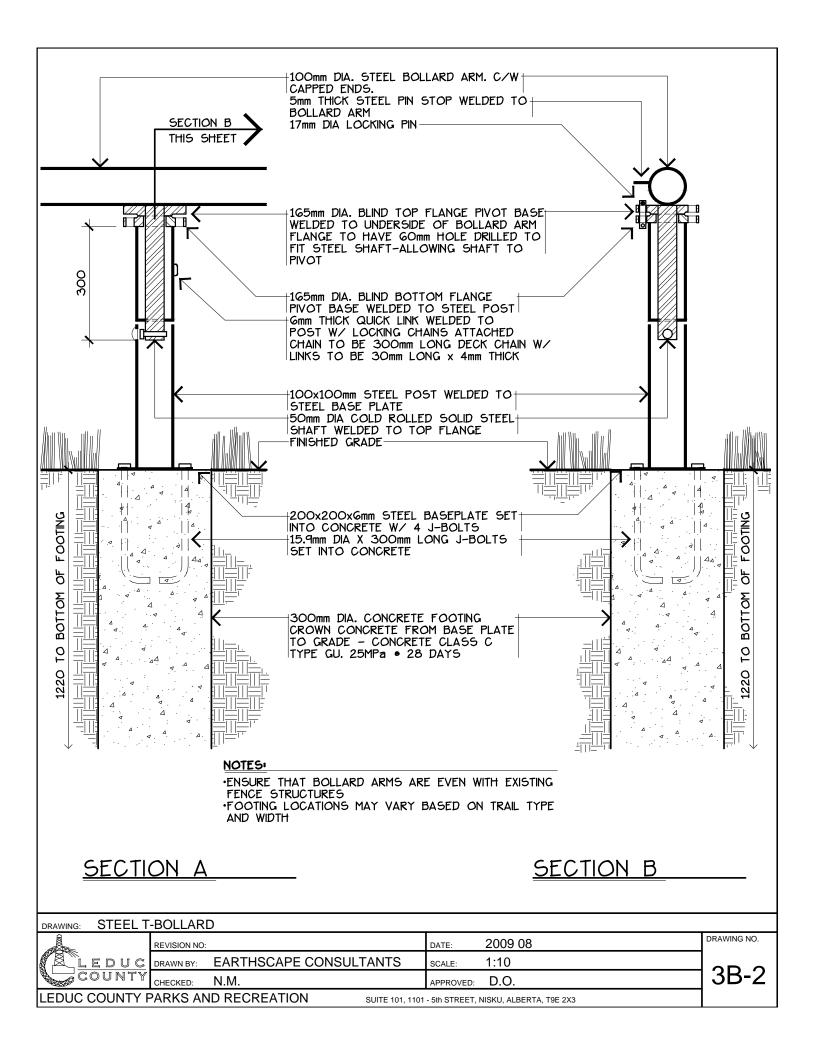


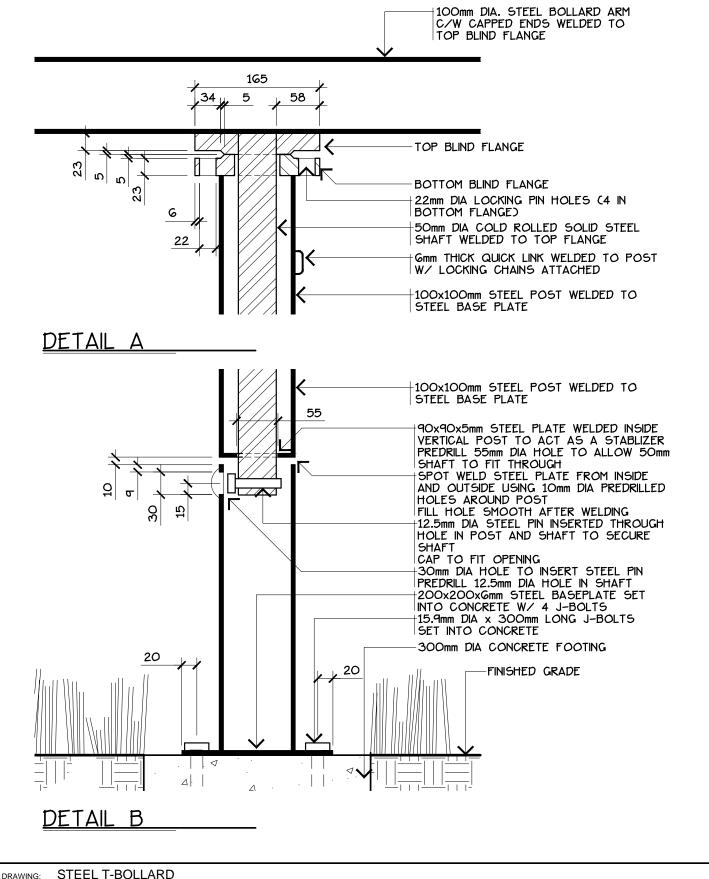


DRAWING. OTLLL	DOLLARI	<u> </u>				
	REVISION NO:			DATE:	2009 08	DRAWING NO.
LEDUC		EARTHSCAPE CO	NSULTANTS	SCALE:	1:5	
COUNTY	CHECKED:	N.M.		APPROVED:	D.O.] 3B-3
LEDUC COUNTY F	PARKS AN	ID RECREATION	SUITE 101, 1101	- 5th STREET,	NISKU, ALBERTA, T9E 2X3	

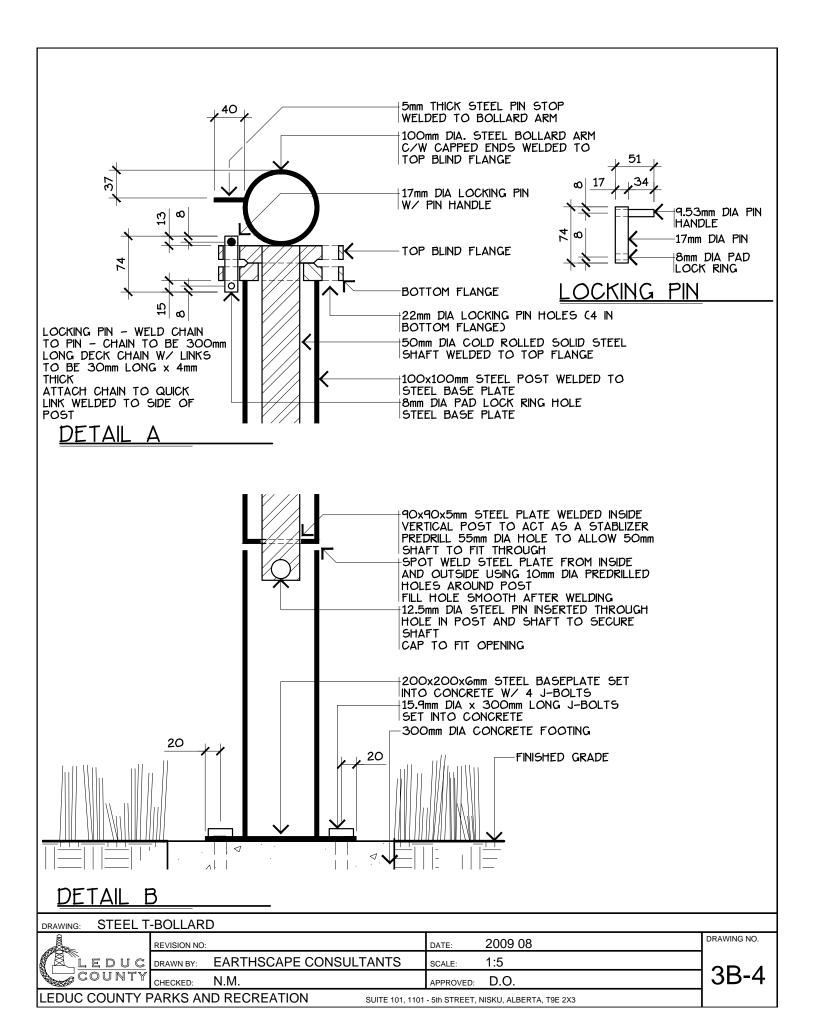


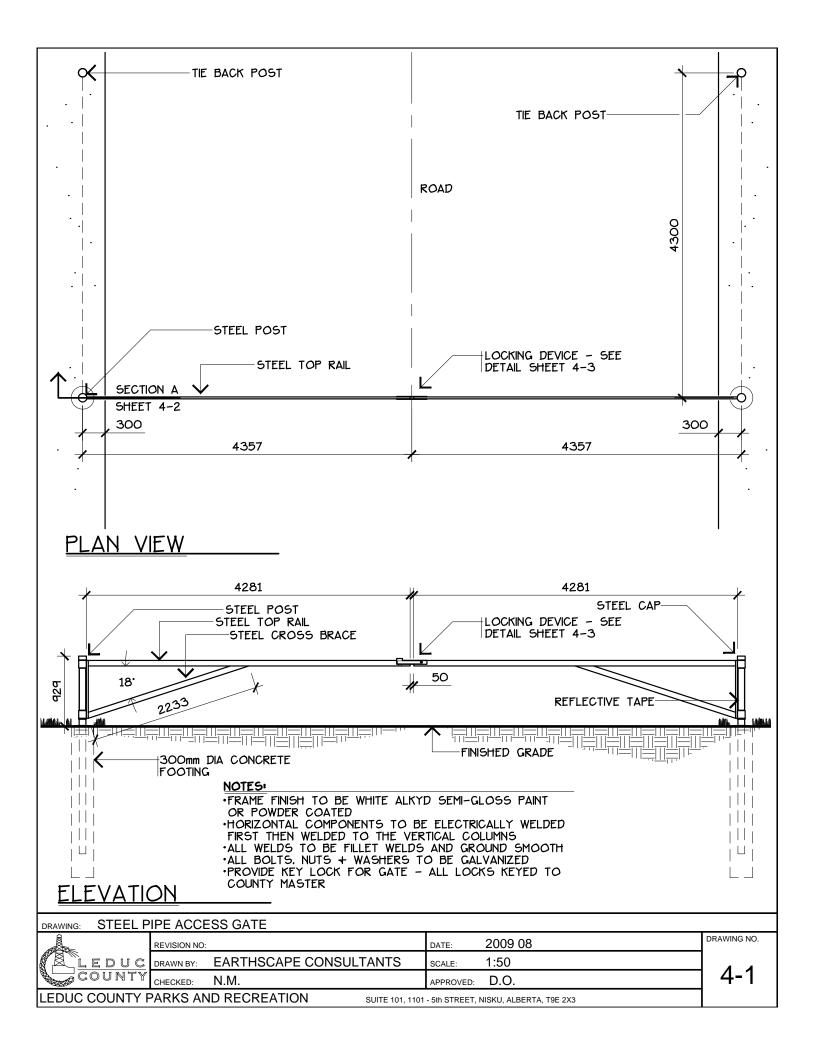

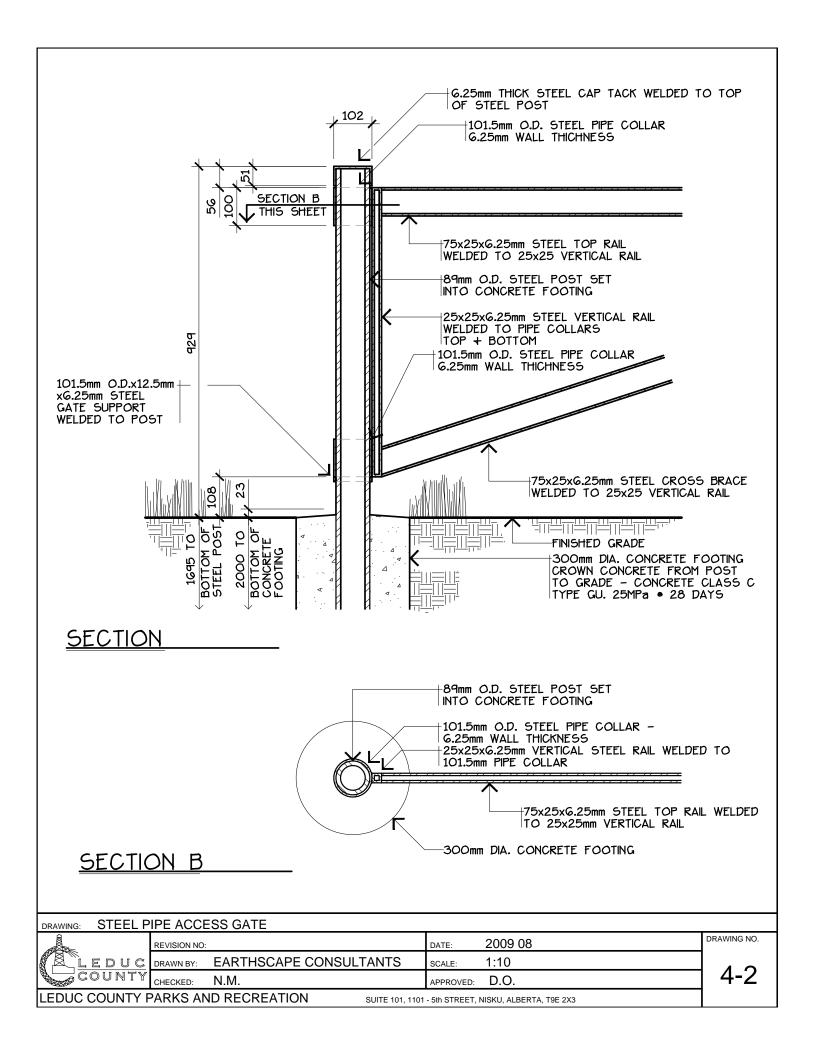


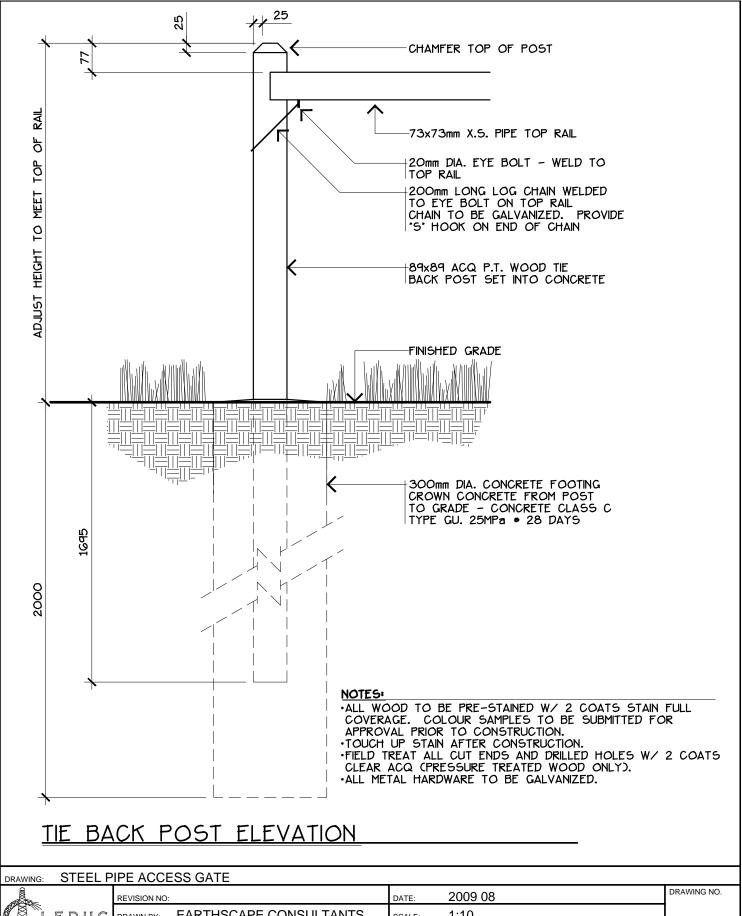


â	REVISION NO:			DATE:	2009 08	DRAWING NO
LEDUC COUNTY	DRAWN BY:	EARTHSCAPE CONSUL	TANTS	SCALE:	1:10] , ,
COUNTY	CHECKED:	N.M.		APPROVED:	D.O.] 4-4
LEDUC COUNTY F	PARKS AN	ID RECREATION	SUITE 101, 1101	- 5th STREET, N	NISKU, ALBERTA, T9E 2X3	

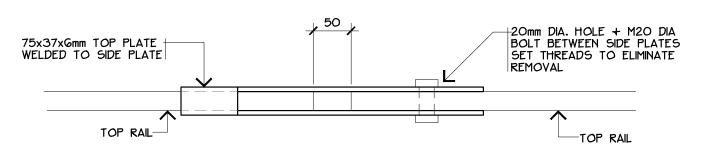

PLAN VIEW

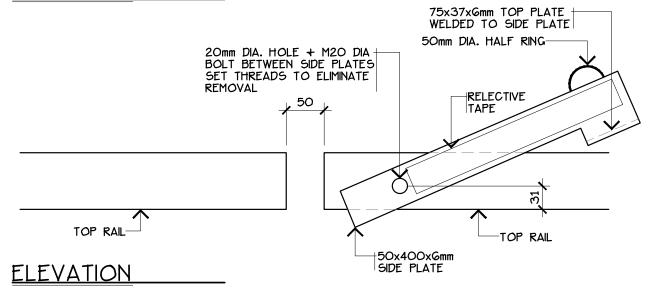

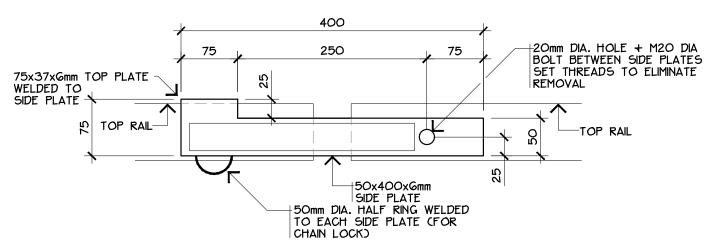

•PROVIDE KEY LOCK FOR GATE - ALL LOCKS KEYED TO COUNTY MASTER


DRAWING NO.

4-3

DETAIL

DRAWING: STEEL PIPE ACCESS GATE

	REVISION NO:		DATE:	2009 08
LEDUC	DRAWN BY:	EARTHSCAPE CONSULTANTS	SCALE:	1:5
COUNTY	CHECKED:	N.M.	APPROVED:	D.O.
LEDUC COUNTY F	PARKS AN	ID RECREATION SUITE 101, 110	- 5th STREET,	NISKU, ALBERTA, T9E 2X3

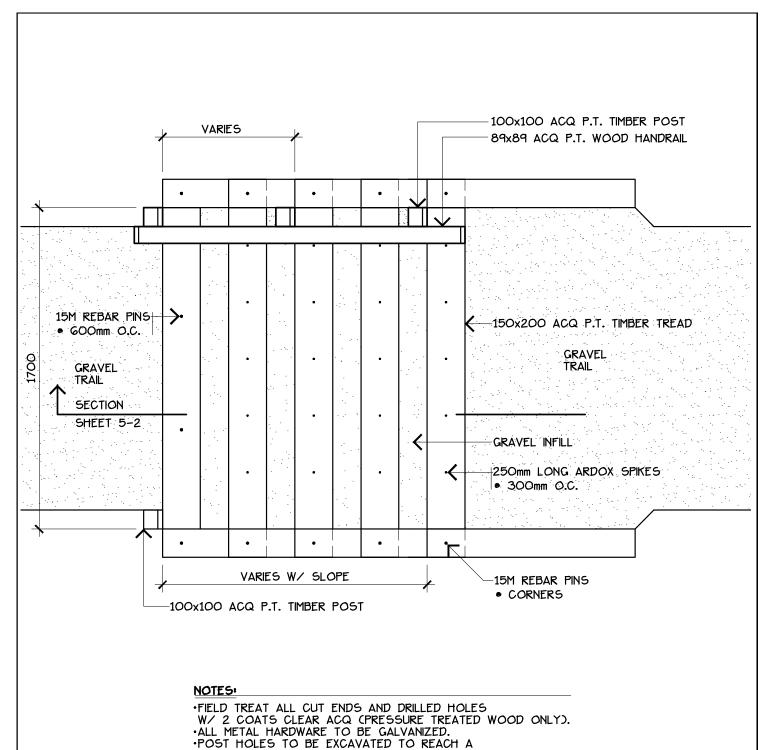

- DEPTH OF UNDISTURBED SUBGRADE.
- ·STAIRS REQUIRED:

ANY SLOPE STEEPER THAN 1:1
ANY SLOPE BETWEEN 1:1 AND 2:1 THAT CANNOT EASILY BE DEVELOPED WITH A SWITCHBACK TRAIL


PLAN VIEW

DRAWING: PRESSURE TREATED TIMBER STAIRS


		REVISION NO:			DATE:	2009 08
	LEDUC	DRAWN BY:	EARTHSCAPE CONSULTANTS		SCALE:	1:20
	LEDUC	CHECKED:	N.M.		APPROVED:	D.O.
LE	DUC COUNTY F	PARKS AN	ID RECREATION SUITE 101,	1101 -	5th STREET, N	NISKU, ALBERTA, T9E 2X3

DRAWING NO.

5-1

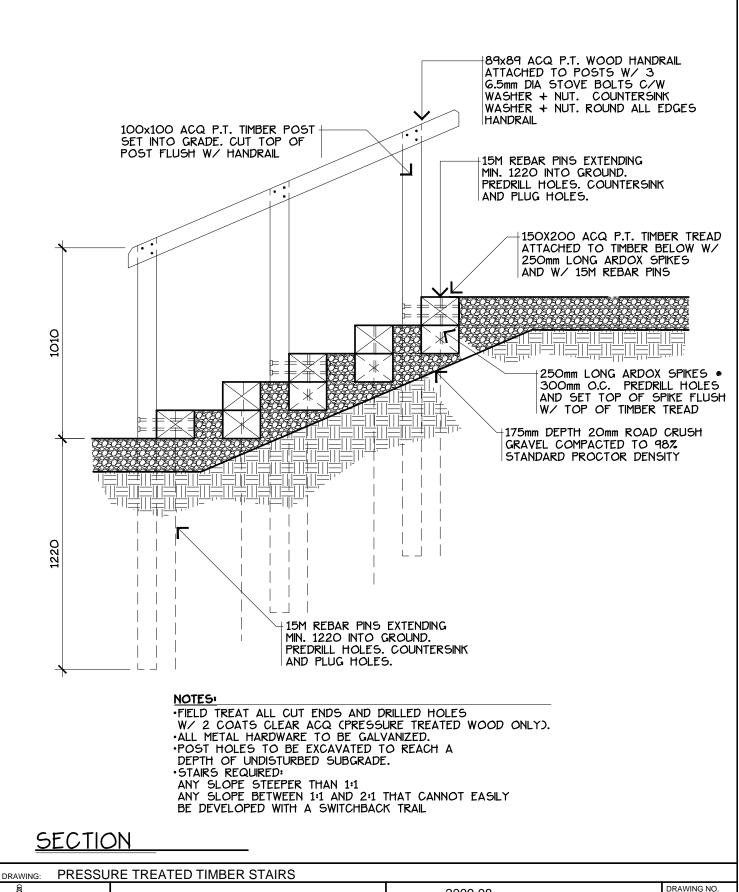

DIVAMINO. I ILLO	OILE IILE	CIED THAIDER OF THE		_		
	REVISION NO	:		DATE:	2009 08	DRAWING NO.
LEDUCOUNT	DRAWN BY:	EARTHSCAPE CO	NSULTANTS	SCALE:	1:20	
COUNT	CHECKED:	N.M.		APPROVED:	D.O.	5-2
LEDUC COUNTY	PARKS A	ND RECREATION	SUITE 101, 1101	- 5th STREET,	NISKU, ALBERTA, T9E 2X3]

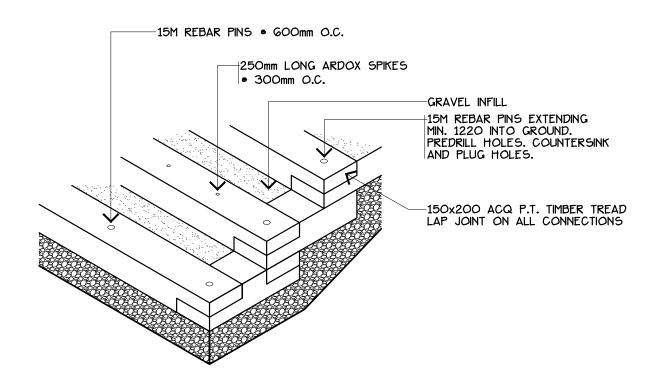

NOTES:

- *FIELD TREAT ALL CUT ENDS AND DRILLED HOLES W/ 2 COATS CLEAR ACQ (PRESSURE TREATED WOOD ONLY).
- •ALL METAIL HARDWARE TO BE GALVANIZED.
 •POST HOLES TO BE EXCAVATED TO REACH A DEPTH OF UNDISTURBED SUBGRADE.
- STAIRS REQUIRED:

ANY SLOPE STEEPER THAN 1:1
ANY SLOPE BETWEEN 1:1 AND 2:1 THAT CANNOT EASILY
BE DEVELOPED WITH A SWITCHBACK TRAIL

<u>ISOMETRIC</u>

DRAWING:	PRESSU	RE TREA	TED TIMBER STAIRS		
Î		REVISION NO:		DATE:	2009 08
		DD AMAL DV	EARTHSCAPE CONSULTANTS	CCALE:	1.20

DRAWN BY: EARTHSCAPE CONSULTANTS SCALE: 1:20


CHECKED: N.M.

APPROVED: D.O.


LEDUC COUNTY PARKS AND RECREATION SUITE 101, 1101 - 5th STREET, NISKU, ALBERTA, T9E 2X3


DRAWING NO.

5-3

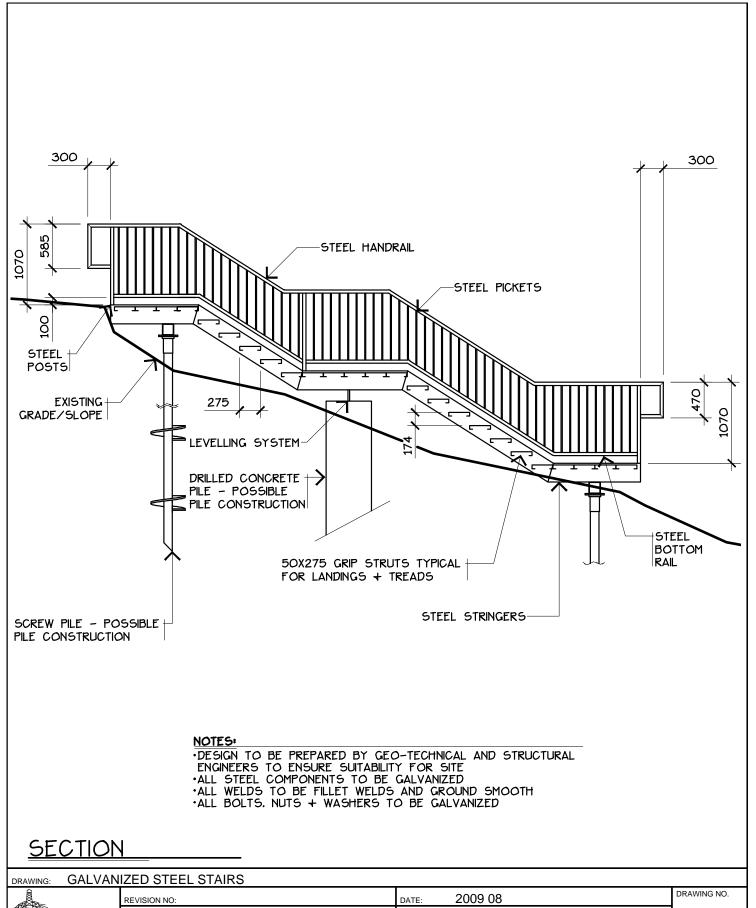


	REVISION NO:		DAT	TE:	2009 08
LEDUC COUNTY	DRAWN BY:	EARTHSCAPE CONSULTANTS	SCA	ALE:	1:50
COUNTY	CHECKED:	N.M.	APF	PROVED:	D.O.
LEDUC COUNTY F	PARKS AN	ND RECREATION SUITE 10	1101 - 5th	STREET, N	NISKU, ALBERTA, T9E 2X3

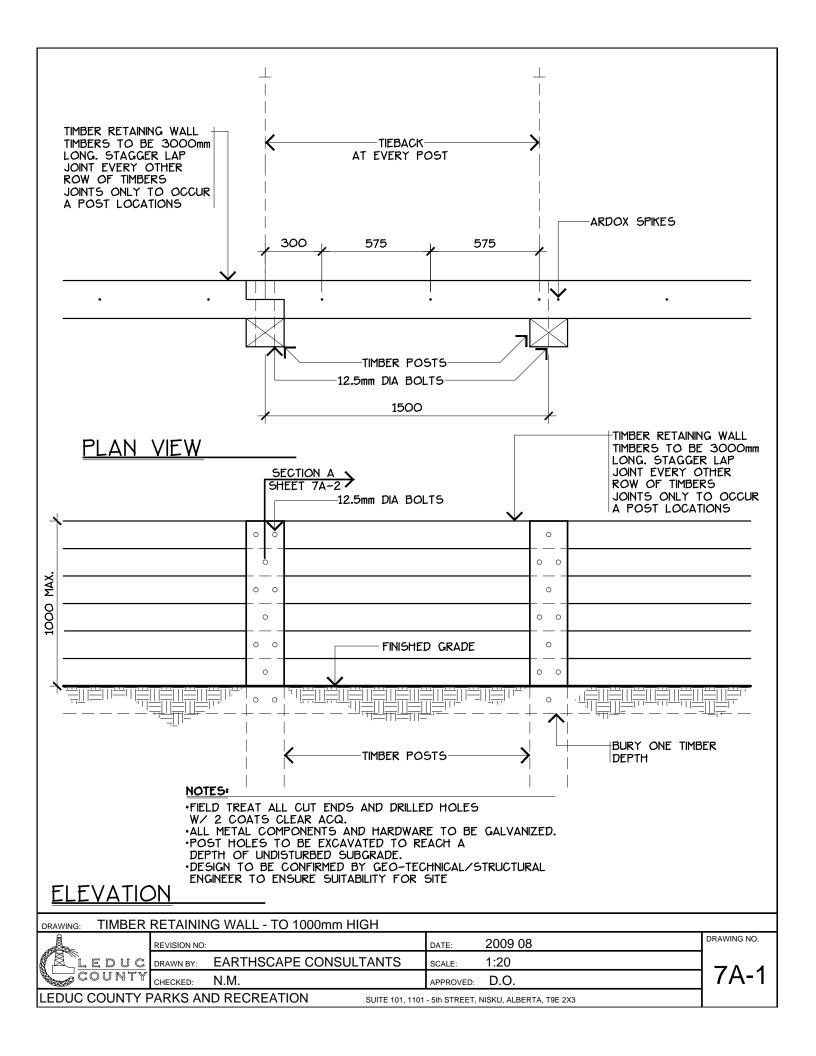

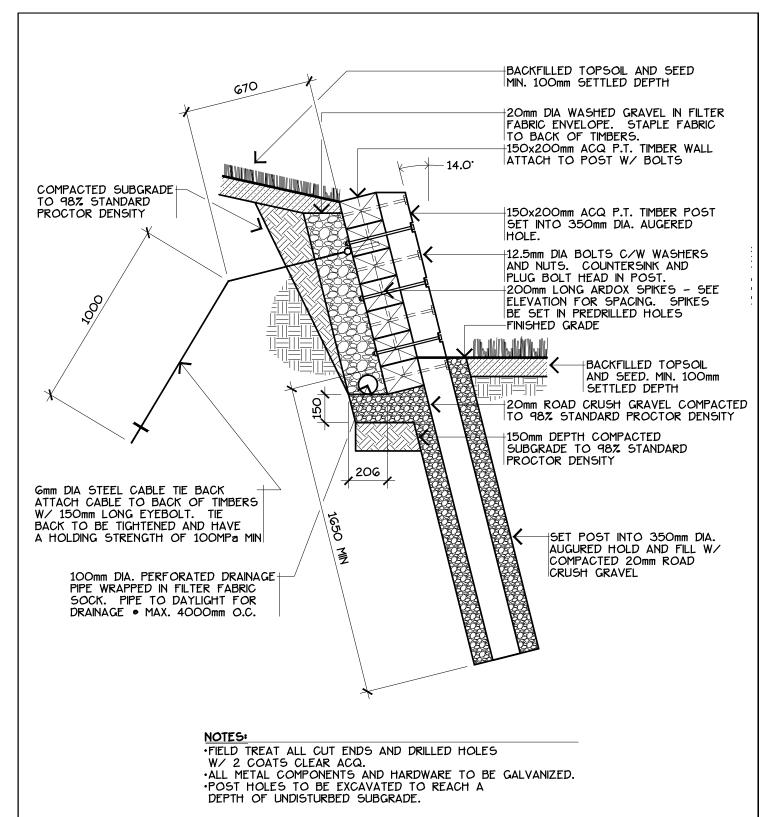


SECTION A

TIMBER RETAINING WALL - TO 1000mm HIGH DRAWING: DRAWING NO. REVISION NO: DATE: 2009 08 EARTHSCAPE CONSULTANTS 1:20 EDUC DRAWN BY: SCALE: 7A-2 COUNTY N.M. D.O. CHECKED: APPROVED: LEDUC COUNTY PARKS AND RECREATION SUITE 101, 1101 - 5th STREET, NISKU, ALBERTA, T9E 2X3

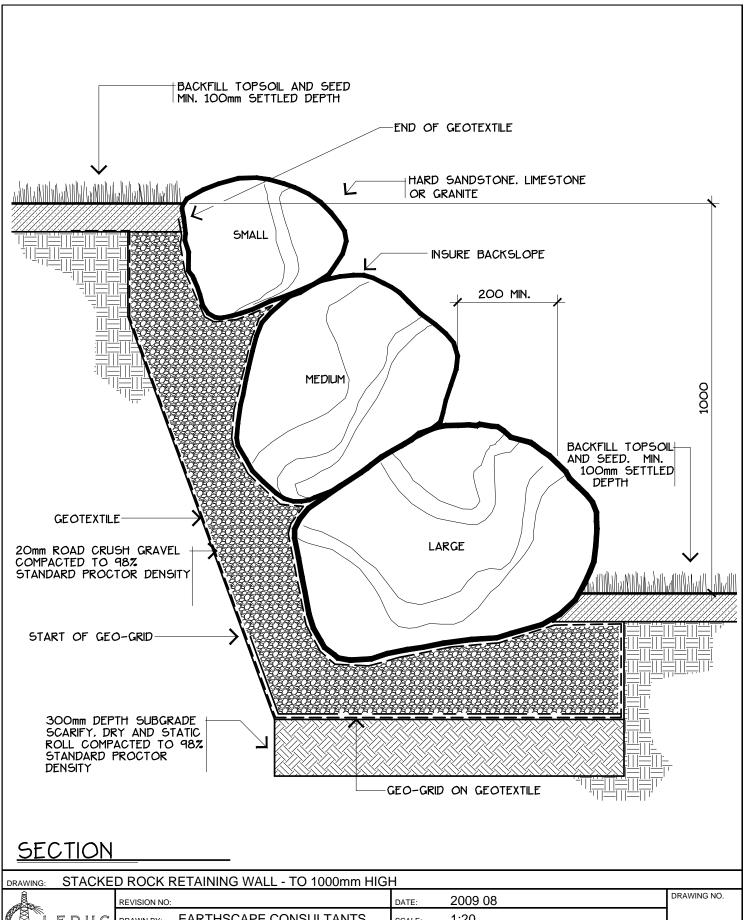


Ì	â					2009 08	DRAWING NO.
ı	ATA CASE	REVISION NO:			DATE:	2009 06	1
l	LEDUC	DRAWN BY:	EARTHSCAPE CONSUL	TANTS	SCALE:	1:20	
l	COUNTY	CHECKED:	N.M.		APPROVED:	D.O.] /B
	LEDUC COUNTY F	PARKS AN	ID RECREATION	SUITE 101, 1101	- 5th STREET, N	NISKU, ALBERTA, T9E 2X3	

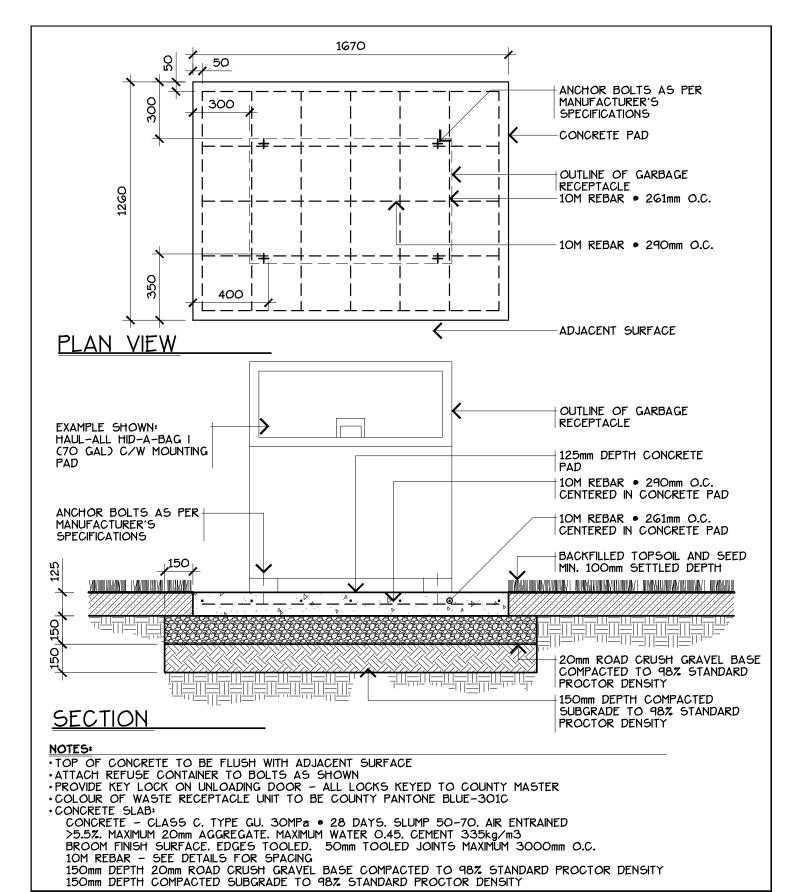


HAUL-A-WAY WASTE RECEPTACLE DRAWING:

DRAWING NO. REVISION NO: DATE: 2009 08 EARTHSCAPE CONSULTANTS 1:20 EDUC DRAWN BY: SCALE: COUNTY N.M. D.O. CHECKED: APPROVED: LEDUC COUNTY PARKS AND RECREATION SUITE 101, 1101 - 5th STREET, NISKU, ALBERTA, T9E 2X3

8

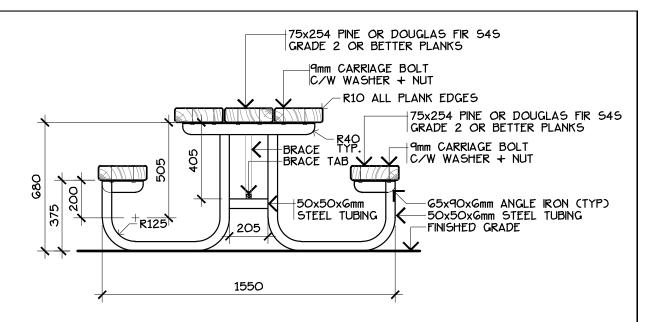

SIDE ELEVATION

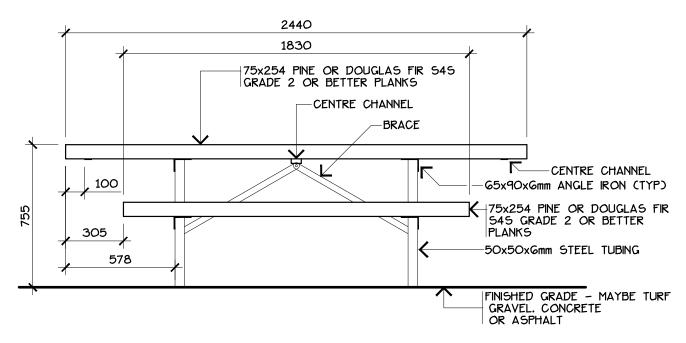

NOTES:

- FRAME FINISH TO BE BLACK ALKYD SEMI-GLOSS PAINT OR POWDER COATED
- ·HORIZONTAL COMPONENTS TO BE ELECTRICALLY WELDED FIRST THEN WELDED TO THE VERTICAL COLUMNS


 *ALL WELDS TO BE FILLET WELDS AND GROUND SMOOTH

 *ALL BOLTS. NUTS + WASHERS TO BE GALVANIZED


- *ALL WOOD COMPONENTS TO BE FINISHED W/ 2 COATS SEMI-TRANSPARENT STAIN COUNTY OF LEDUC STANDARDS


FRONT ELEVATION

DRAWING: PORTAB	LE PICNI	<u>C TABLE - ELEVATI</u>	ONS			
	REVISION NO:			DATE:	2009 08	DRAWING NO.
LEDUC	DRAWN BY:	EARTHSCAPE CO	NSULTANTS	SCALE:	1:20	0 1 4
COUNTY	CHECKED:	N.M.		APPROVED:	D.O.	9A-1
LEDUC COUNTY F	PARKS AN	ND RECREATION	SUITE 101, 1101	- 5th STREET. I	NISKU, ALBERTA, T9E 2X3	

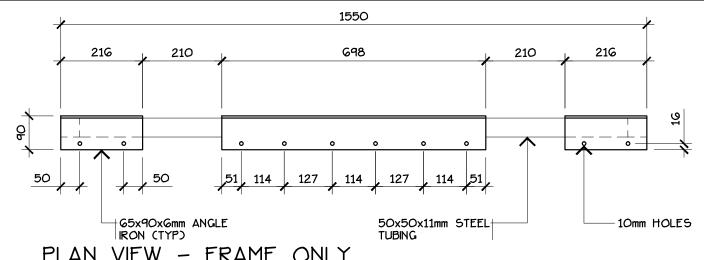


PLAN VIEW - FRAME ONLY

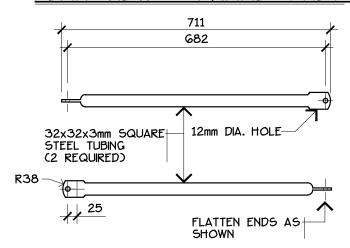

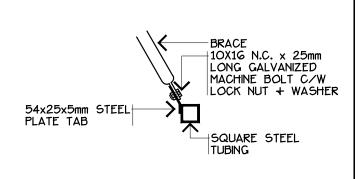

BRACE DETAIL

BRACE TAB DETAIL

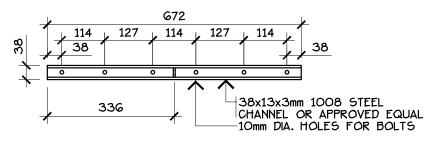

54x25x5mm STEEL PLATE TAB CENTRE CHANNEL ONLY


CHANNEL DETAIL

DRAWING:	PORTABLI	E PICNIC	TABLE -	- DETAILS
----------	----------	-----------------	---------	-----------


	REVISION NO:		DATE:	2009 08
LEDUC	DRAWN BY:	EARTHSCAPE CONSULTANTS	SCALE:	1:10
LEDUC	CHECKED:	N.M.	APPROVED:	D.O.
LEDLIC COUNTY F	ΣΔΡΚΟ ΔΝ	ID RECREATION SHITE 101 1101	5th CTDEET	NICKLI ALBERTA TOE 2V2

9A-2

DRAWING NO.

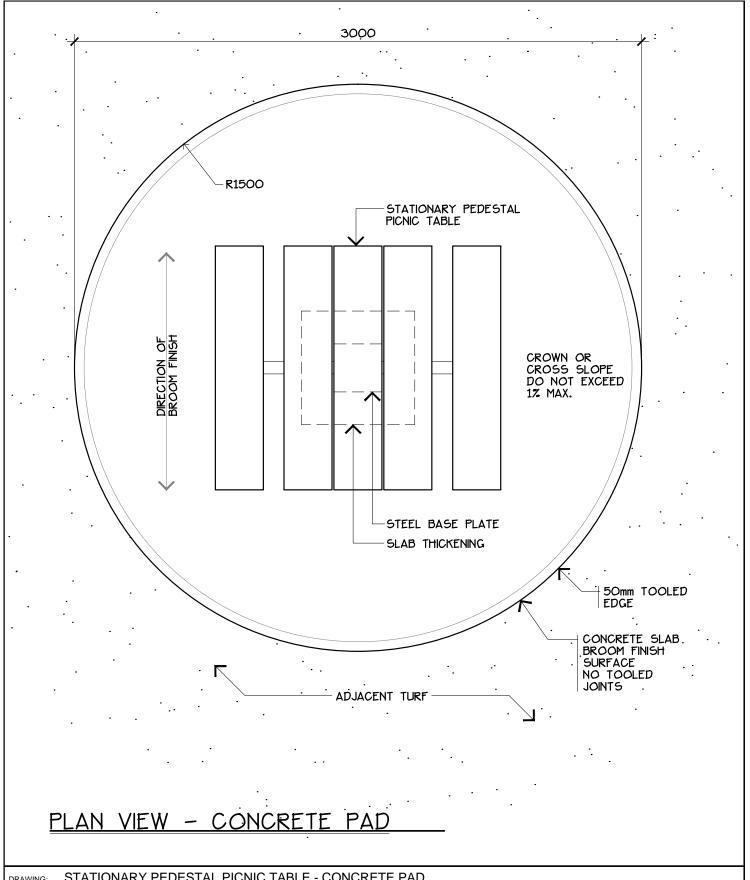

DRAWING: STATION	IARY PED	<u>ESTAL PICNIC TA</u>	BLE - CONCRETE	: PAD		
	REVISION NO: DA		DATE:	2009 08	DRAWING NO.	
LEDUC	DRAWN BY:	EARTHSCAPE CO	ONSULTANTS	SCALE:	1:20	
COUNTY	CHECKED:	N.M.		APPROVED:	D.O.	9B-1
LEDUC COUNTY F	PARKS AN	ID RECREATION	SUITE 101, 1101	- 5th STREET,	NISKU, ALBERTA, T9E 2X3	

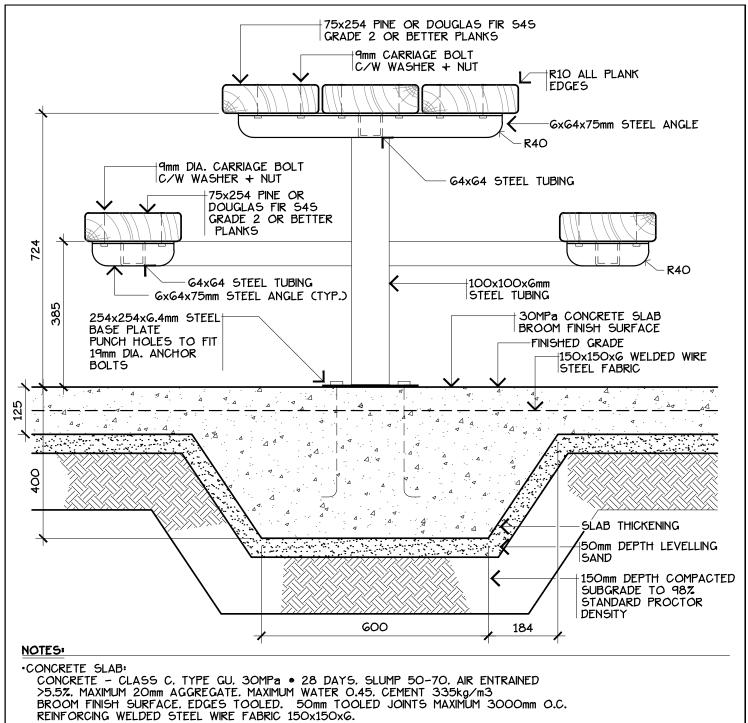

50mm DEEP LEVELLING SAND

150mm DEEP COMPACTED SUBGRADE TO 98%

STANDARD PROCTOR DENSITY

•FRAME FINISH TO BE BLACK ALKYD SEMI-GLOSS PAINT OR POWDER COATED


*HORIZONTAL COMPONENTS TO BE ELECTRICALLY WELDED FIRST THEN WELDED TO THE VERTICAL COLUMNS

*ALL WELDS TO BE FILLET WELDS AND GROUND SMOOTH *ALL BOLTS. NUTS + WASHERS TO BE GALVANIZED *ALL WOOD COMPONENTS TO BE FINISHED W/ 2 COATS

SEMI-TRANSPARENT STAIN COUNTY OF LEDUC STANDARDS

ELEVATION

DRAWING: STATION	<u>IARY PED</u>	<u>DESTAL PICNIC TAI</u>	BLE			
	REVISION NO:			DATE:	2009 08	DRAWING NO.
LEDUC	DRAWN BY:	EARTHSCAPE CC	ONSULTANTS	SCALE:	1:10	
LEDUC	CHECKED:	N.M.		APPROVED:	D.O.	J 9B-2
LEDUC COUNTY F	ARKS AN	ND RECREATION	SUITE 101, 1101	- 5th STREET, I	NISKU, ALBERTA, T9E 2X3	

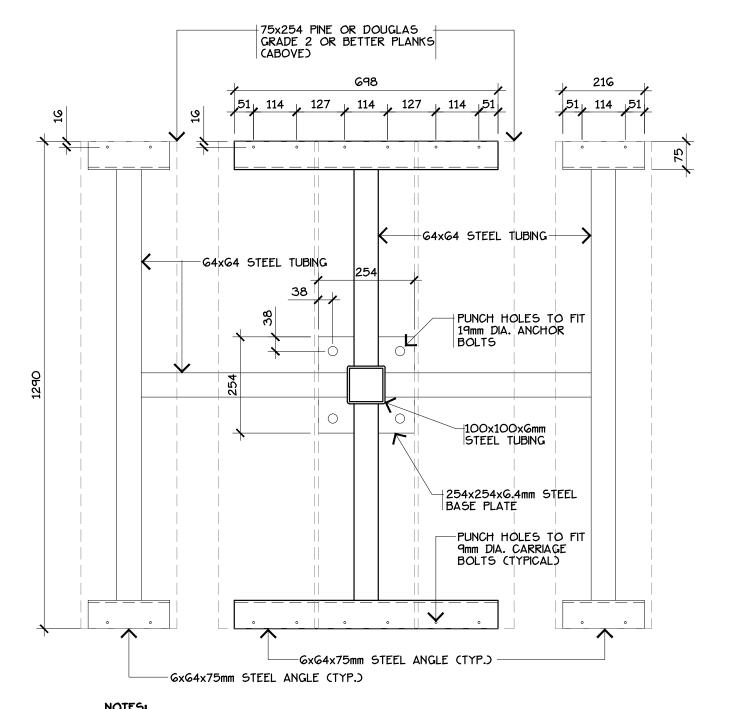

NOTES:


- FRAME FINISH TO BE BLACK ALKYD SEMI-GLOSS PAINT
- OR POWDER COATED ... HORIZONTAL COMPONENTS TO BE ELECTRICALLY WELDED FIRST THEN WELDED TO THE VERTICAL COLUMNS


 *ALL WELDS TO BE FILLET WELDS AND GROUND SMOOTH

 *ALL BOLTS. NUTS + WASHERS TO BE GALVANIZED


PLAN VIEW - FRAME ONLY

DRAWING: STATION	<u>19KA HEL</u>	<u>DESTAL PICNIC TABI</u>	<u>LE</u>			
ACCOUNT OF THE PROPERTY OF THE	REVISION NO:	:		DATE:	2009 08	DRAWING NO.
LEDUC	DRAWN BY:	EARTHSCAPE CON	NSULTANTS	SCALE:	1:10	00.0
COUNTY	CHECKED:	N.M.		APPROVED:	D.O.	9B-3
LEDUC COUNTY F	PARKS AN	ND RECREATION	SUITE 101 1101	- 5th STREET I	NISKII ALBERTA T9E 2X3	 1

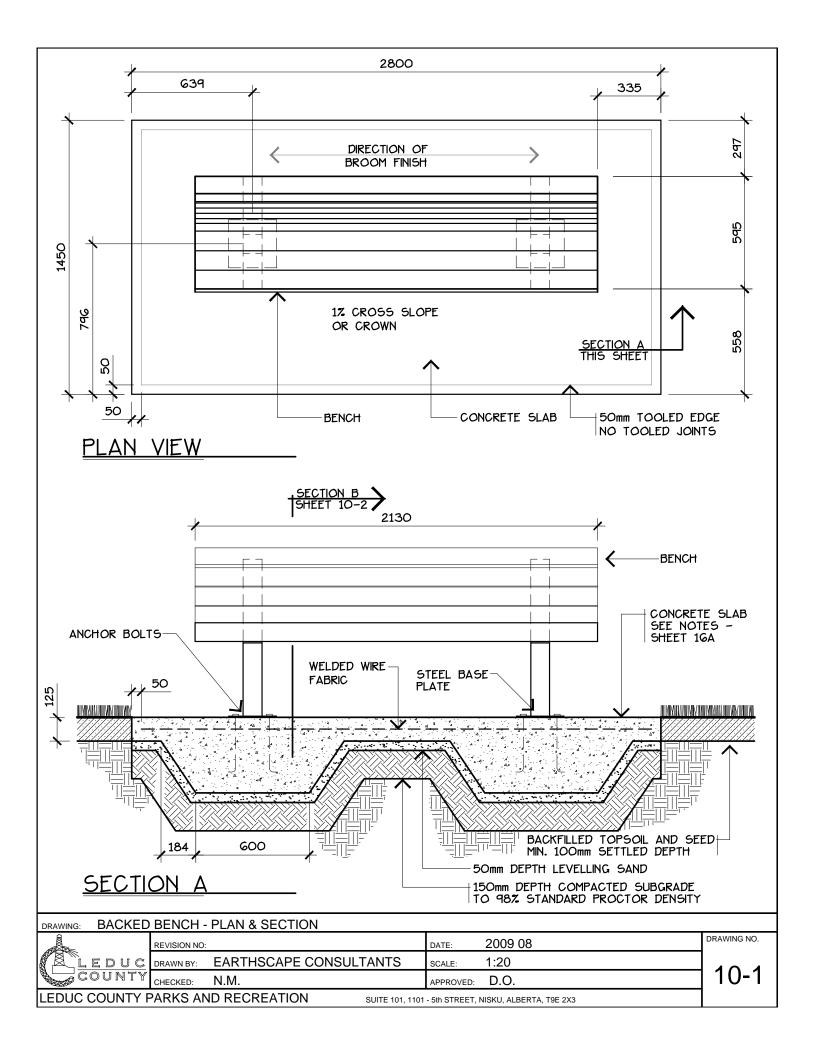

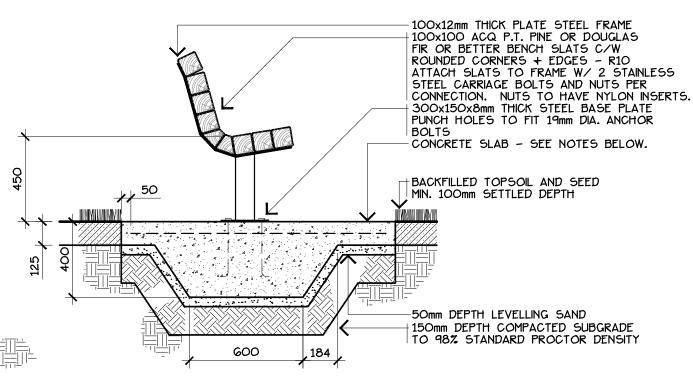

SECTION B

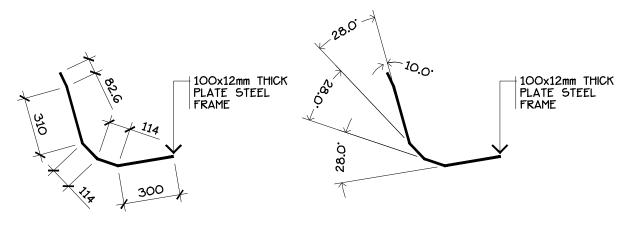

STEEL FRAME DETAIL

NOTES:


· CONCRETE SLAB:


CONCRETE - CLASS C. TYPE GU. 30MPa • 28 DAYS. SLUMP 50-70. AIR ENTRAINED >5.5%. MAXIMUM 20mm AGGREGATE. MAXIMUM WATER 0.45. CEMENT 335kg/m3 BROOM FINISH SURFACE. EDGES TOOLED. 50mm TOOLED JOINTS MAXIMUM 3000mm O.C. REINFORCING WELDED STEEL WIRE FABRIC 150x150xG. 50mm DEEP LEVELLING SAND

150mm DEEP COMPACTED SUBGRADE TO 98% STANDARD PROCTOR DENSITY

- ·ALL WELDS TO BE FULL WELDS GROUND SMOOTH ·ALL METAL COMPONENTS TO BE BLACK ALKYD SEMI-
- GLOSS PAINT OR POWDER COATED
- ·ALL WOOD COMPONENTS TO BE FINISHED W/ 2 COATS SEMI-TRANSPARENT STAIN COUNTY OF LEDUC STANDARDS

BACKED BENCH - SECTION & DETAILS DRAWING: DRAWING NO. REVISION NO: DATE: 2009 08 DRAWN BY: EARTHSCAPE CONSULTANTS 1:20 EDUC SCALE COUNTY 10-2 N.M. D.O. CHECKED: APPROVED: LEDUC COUNTY PARKS AND RECREATION SUITE 101, 1101 - 5th STREET, NISKU, ALBERTA, T9E 2X3

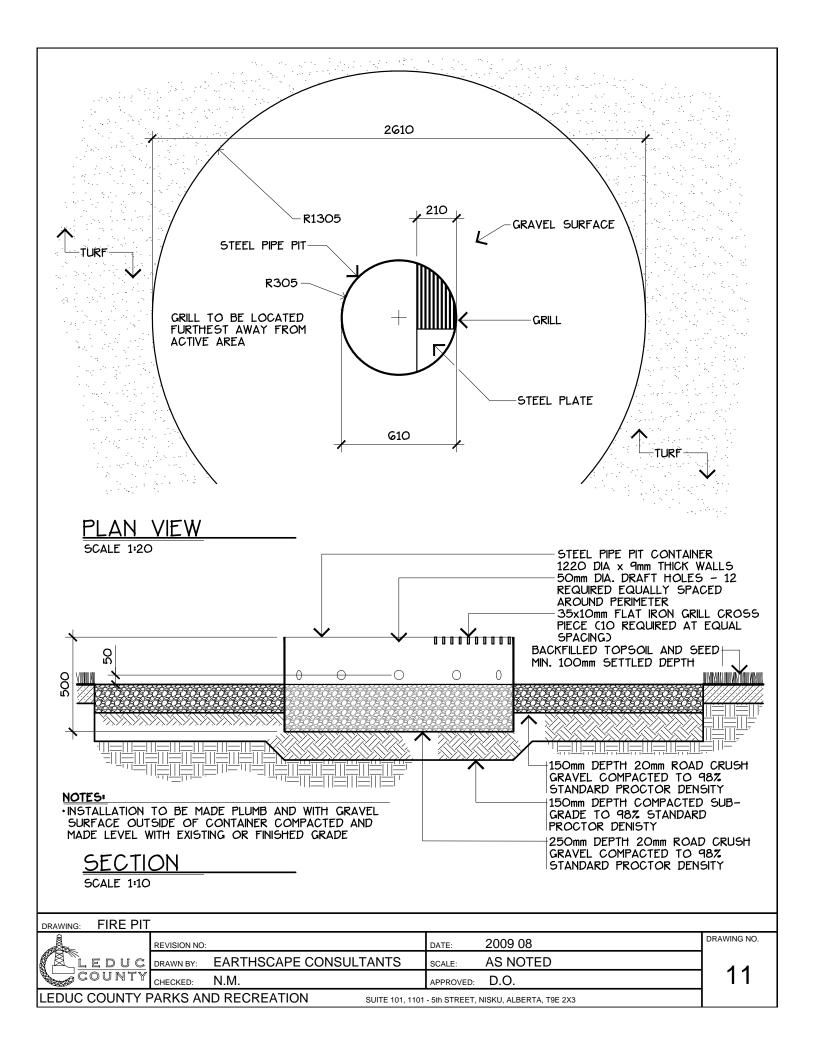

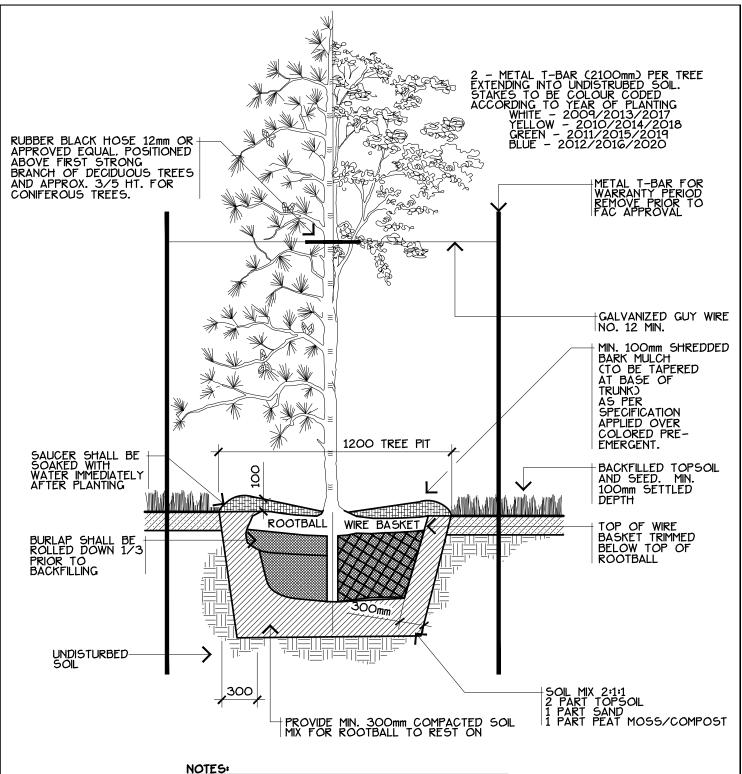

- ·PRUNE ONLY TO REMOVE DEAD. DAMAGED. DISEASED
- OR INTERFERING WOOD.


 CONTRACTOR TO ALLOW FOR SETTLEMENT WHEN PLACING THE TREE.

DRAWING:	TREE	PLANTING
^		1

Û		REVISION NO:			DATE:	2009 08
L E CO	DUC	DRAWN BY:	EARTHSCAPE CONSULT	TANTS	SCALE:	NTS
CO	UNTY	CHECKED:	N.M.		APPROVED:	D.O.
LEDUC COUNTY PARKS AND RECREATION SUITE 101, 1101 - 5th STREET, NISKU, ALBERTA, 198						NISKU, ALBERTA, T9E 2X3

DRAWING NO.

12-1

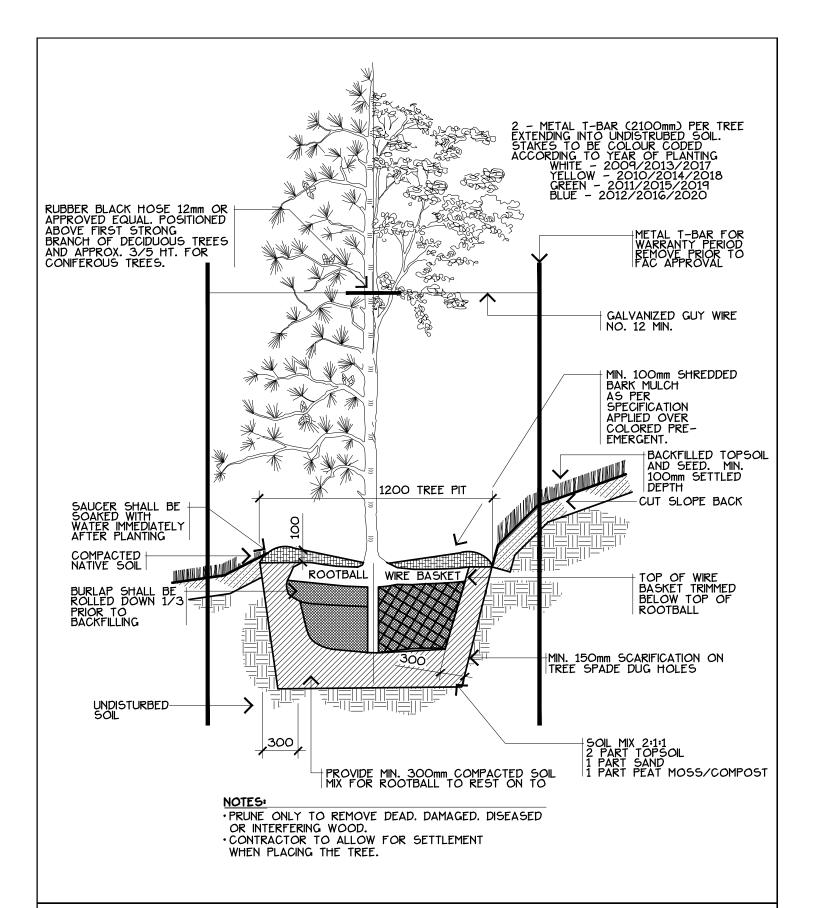

DRAWING:	TREE PLANTING ON SLOPES
Δ	

REVISION NO:

DATE: 2009 08

LEDUC DRAWN BY: EARTHSCAPE CONSULTANTS SCALE: NTS


CHECKED: N.M.

APPROVED: D.O.

LEDUC COUNTY PARKS AND RECREATION SUITE 101, 1101 - 5th STREET, NISKU, ALBERTA, T9E 2X3

12-2


DRAWING NO.

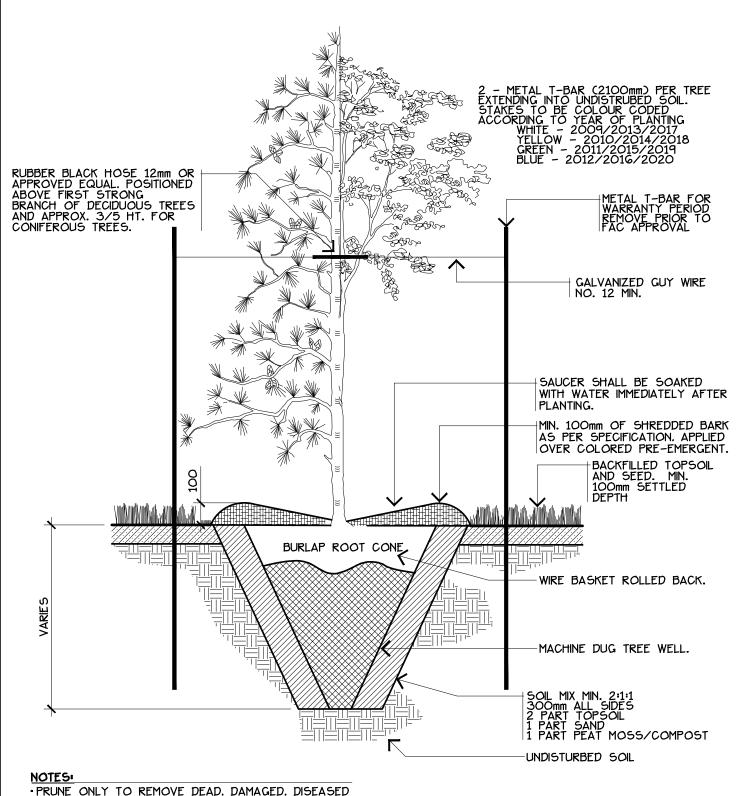


- PRUNE ONLY TO REMOVE DEAD. DAMAGED. DISEASED OR INTERFERING WOOD.
- CONTRACTOR TO ALLOW FOR SETTLEMENT WHEN PLACING THE TREE.


DRAWING:	MACHINE DUG TREE


	REVISION NO:			DATE:	2009 08	DRAWING NO.
LEDUC	DRAWN BY:	EARTHSCAPE CONSUL	LTANTS	SCALE:	NTS	400
COUNTY	CHECKED:	N.M.		APPROVED:	D.O.	12-3
LEDUC COUNTY F	PARKS AN	ND RECREATION	SUITE 101, 1101	- 5th STREET, I	NISKU, ALBERTA, T9E 2X3	

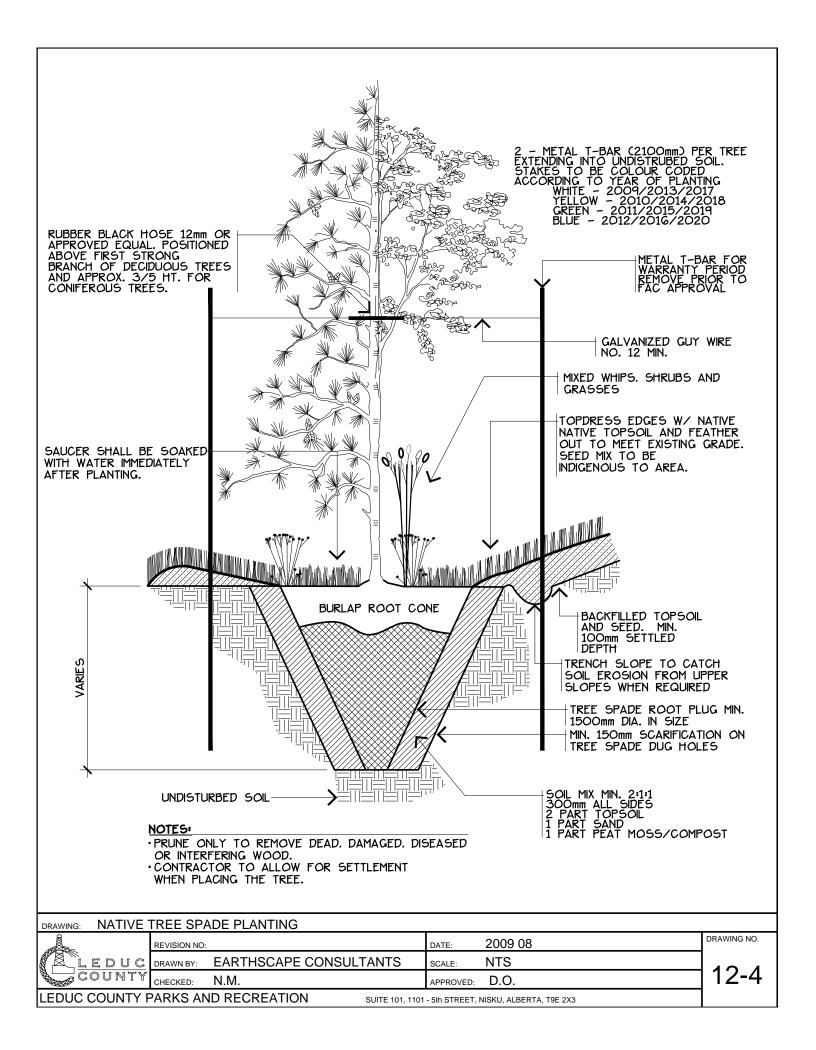

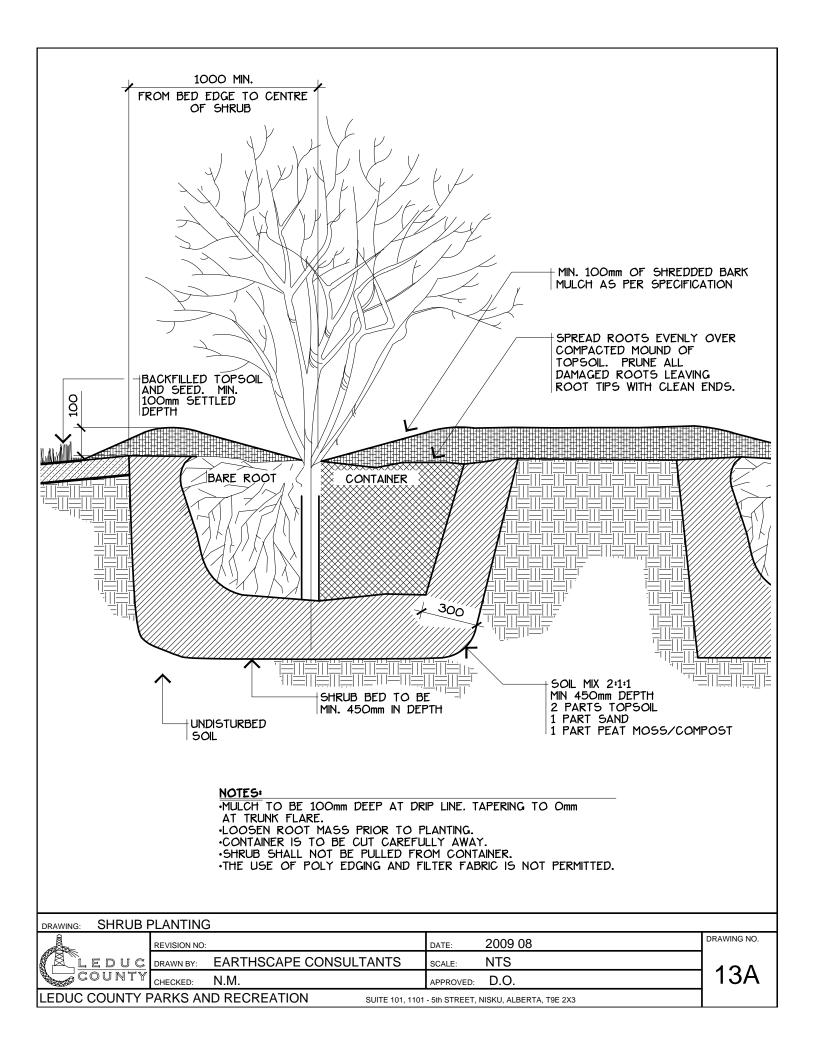


- FINAL SUBGRADE MINIMUM SLOPE 1% SPORT FIELDS, 1.5% OTHER, MAXIMUM SLOPE 33%
- *SUBGRADE COMPACTED TO 95% STANDARD PROCTOR DENSITY
- •TILL SUBGRADE AREAS COMPACTED MORE THAN 95% TO A DEPTH OF 150 mm
- *SCARIFY UPPER SURFACE OF ALL SUBGRADE
- SUPPLY + INSTALL 100mm (SOD) 100mm MIN. (SEED) SETTLED DEPTH OF APPROVED TOPSOIL
- *SUPPLY + INSTALL 12-51-O FERTILIZER AT 3.5 KG/100 m2 ON TOP OF TOPSOIL
- •SUPPLY + INSTALL STANDARD SOD IN LARGE ROLLS OR SMALLER PIECES
- *DELIVER SOD TO SITE WITHIN 24 HOURS OF BEING LIFTED AND LAY SOD WITHIN 36 HOURS OF BEING LIFTED
- •FULL ROW OF SOD FOR BED EDGES TO CREATE SMOOTH FREE FLOWING LINES
- *TOPDRESS ANY JOINTS THAT DRY OUT AND OPEN UP
- •MAINTAIN VIGOROUS + WEED FREE TO FINAL ACCEPTANCE CERTIFICATE APPROVAL
- SOD SEED MIX:30% TOUCHDOWN BLUEGRASS, 40% KENTUCKY BLUEGRASS, 35% CREEPING RED FESCUE
- PARK SEED MIX:30% TOUCHDOWN BLUEGRASS, 40% KENTUCKY BLUEGRASS, 35% CREEPING RED FESCUE
- •NATIVE SEED MIX:35% FAIRWAY CRESTED WHEATGRASS, 20% NAKISKA SHEEPS FESCUE.
- •20% DURAR HARD FESCUE. 105 NORLAC RED CLOVER. 10% BIRDSFOOT TREFOIL. 5% PERENNIAL RYEGRASS FOR NON-MOWED AREAS
- •RIPARIAN SEED MIX:25% FOWL BLUEGRASS. 20% ROCKY MOUNTAIN FESCUE. 20%
- •HIGHLANDER SLENDER WHEATGRASS. 15% ALKALIGRASS. 105 HARD FESCUE. 10%
- SLOUGHGRASS, 5% HAIRY VETCH FOR 1000mm ELEVATION ABOVE + BELOW NORMAL WATER LEVEL
- SPREAD ALL SEED AT 240 KG/HECTARE OR AS SPECIFIED FOR THE SEED TYPE.
- *SEED TO BE SPREAD IN TWO PASSES AT OPPOSITE DIRECTIONS
- •HYDROSEEDING FOR SLOPES 3:1 OR STEEPER TO FOLLOW STANDARD HYDROSEEDING PRACTICES

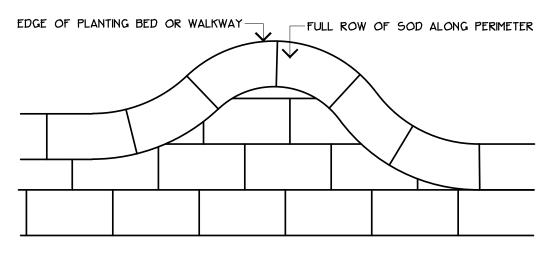

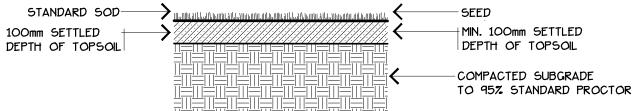

DRAWING: SEED AN	ND SOD D	ETAIL				
	REVISION NO:			DATE:	2009 08	DRAWING NO.
LEDUC	DRAWN BY:	EARTHSCAPE CONSULT	TANTS s	SCALE:	NTS	400
COUNTY	CHECKED:	N.M.	A	APPROVED:	D.O.	13B
LEDIIC COLINTY F	DARKS AN	ID RECREATION	CUITE 101 1101	Eth OTDEET N	IICKLI ALBERTA TOE 2V2	1

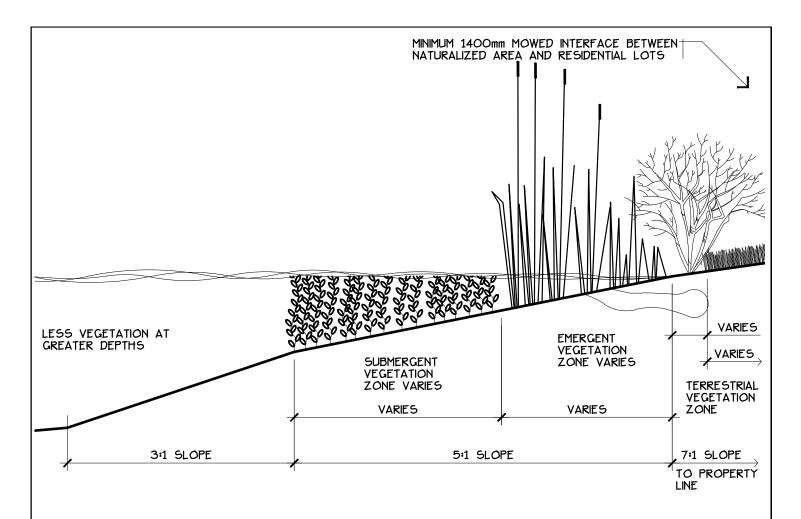

- DENSE SHORELINE DISCOURAGES GOOSE ACCESS TO RIPARIAN AND ORNAMENTAL VEGETATION
- ·SETBACK BETWEEN SHORE OF NWL AND PROPERTY LINE CONTAINS UNDERMINING OF SHORE BY MUSKRATS ON PUBLIC PROPERTY
- ·VEGETATED. NATURALIZED SHORELINE RESULTS IN IMPROVED WATER QUALITY AND STABLIZES BANKS AND SHORE.
- DECREASES EROSION AND IMPROVES AESTHETIC QUALITY


 THERE ARE THREE ZONES THAT NEED TO BE IDENTIFIED WIDTHS VARY ON A SITE BY SITE BASIS

 SWMF DESIGN TO BE CONSISTENT WITH LEDUC COUNTY'S DESIGN GUIDELINES AND CONSTRUCTION STANDARDS FOR DEVELOPMENTS. CHAPTER 6
- PLANT MATERIAL SHALL BE SELECTED TO RESPECT SOIL CHARACTERISTICS, SLOPES, VEGETATION AND DESIGN OF THE FACILITY AND ITS INTENDED USE
- ·MINIMUM 75 TREES PER HECTARE REQUIRED BASED ON AREA ABOVE THE NORMAL WATER LEVEL (NWL). SHRUBS MAY
- BE SUBSTITUTED AT A RATE OF 5 SHRUBS TO ONE TREE.


 PLANT MATERIAL MUST BE APPROPRIATE TO WITHSTAND FLOODING CONDITIONS AND SHOULD DETER DIRECT PUBLIC ACCESS TO THE WETLAND
- ·MINIMUM BUFFER WIDTH OF 10m OF VEGETATION AROUND THE PERIMETER OF THE POND IS REQUIRED FOR EROSION CONTROL AND SEDIMENT/NUTRIENT REMOVAL. AFTER TOPSOIL HAS BEEN PLACED. THE ENTIRE VEGETATION AREA SHALL SEEDED WITH A RIPARIAN SEED MIX TO STABILIZE THE SOIL
- IN THE SPRING OF THE YEAR FOLLOWING CONSTRUCTION THE ENTIRE VEGETATION ZONE SHALL BE OVERSEEDED WITH LEGUMES AND OTHER NATIVE WETLAND MATERIAL. AT APPROXIMATELY THE SAME TIME THE AREA ABOVE THE NWL SHALL BE PLANTED WITH WOODY SPECIES
- PRIOR TO FAC AND TWO YEARS AFTER CCC A DIVERSE POPULATION OF WETLAND VEGETATION AND TOLERANT WOODY PLANTS SHOULD BE ESTABLISHED
- ·TO ACCOMMODATE RECREATIONAL USES FOR THE PUBLIC, A WALKWAY MAY BE REQUIRED IN THE BUFFER STRIP BETWEEN THE NWL AND HIGH WATER LEVEL AT THE DISCRETION OF LEDUC COUNTY


SECTION

DRAWING: STORM	WATER MA	<u>ANAGEMENT FACILIT</u>	TY (SWMF) PLA	ANTING		
	REVISION NO:			DATE:	2009 08	DRAWING NO.
LEDUC		EARTHSCAPE CONS	SULTANTS	SCALE:	1:75	
COUNTY	CHECKED:	N.M.		APPROVED:	D.O.] 14
LEDUC COUNTY F	ARKS AN	D RECREATION	SUITE 101, 1101	- 5th STREET, N	NISKU, ALBERTA, T9E 2X3	

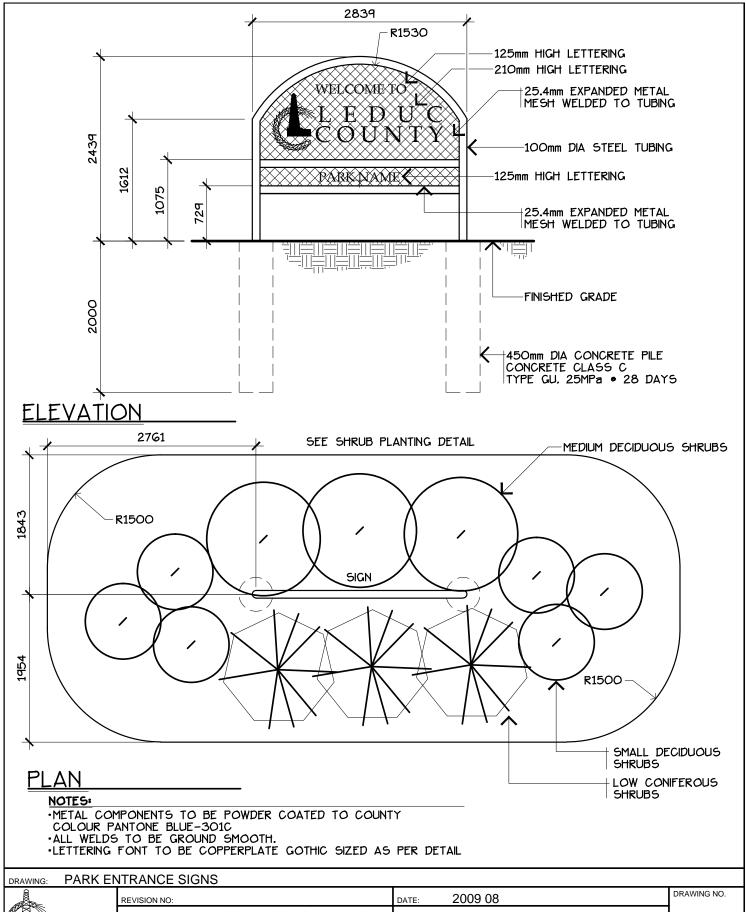


	REVISION NO:			DATE:	2009 08	DRAWING NO.
LEDUC	DRAWN BY:	EARTHSCAPE CO	ONSULTANTS	SCALE:	1:50	
LEDUC	CHECKED:	N.M.		APPROVED:	D.O.] 15-1
LEDUC COUNTY F	PARKS AN	ID RECREATION	SUITE 101, 1101	- 5th STREET, I	NISKU, ALBERTA, T9E 2X3	

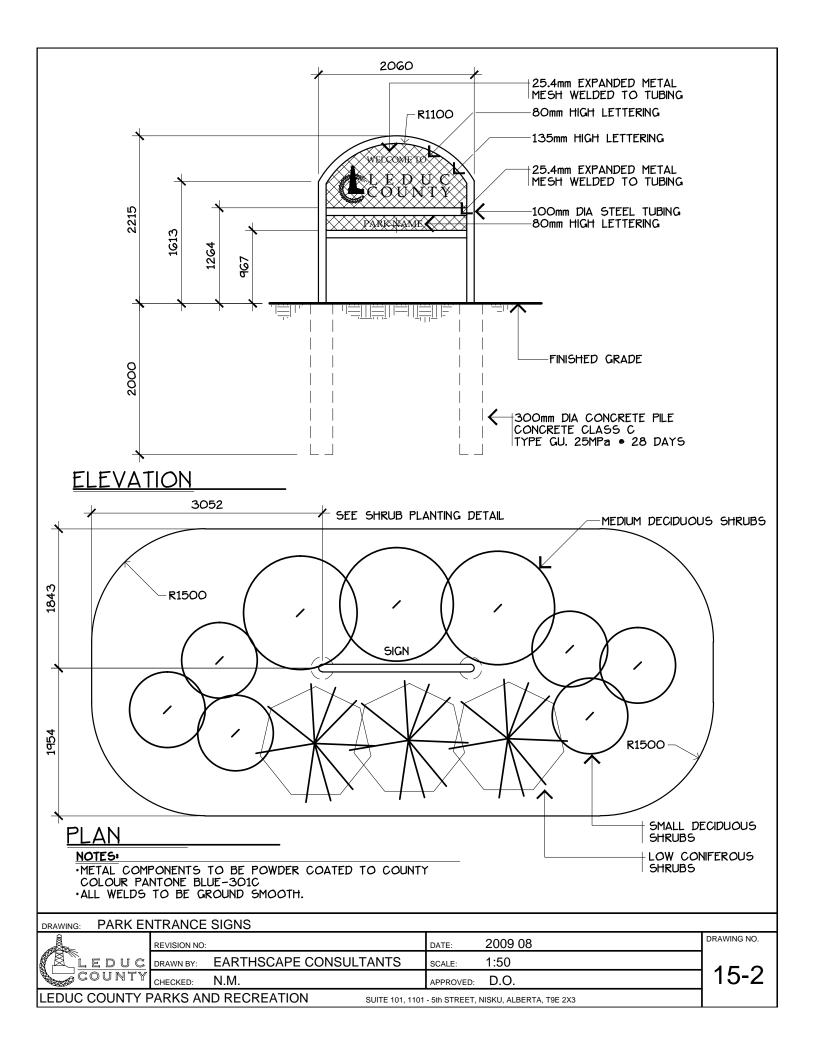

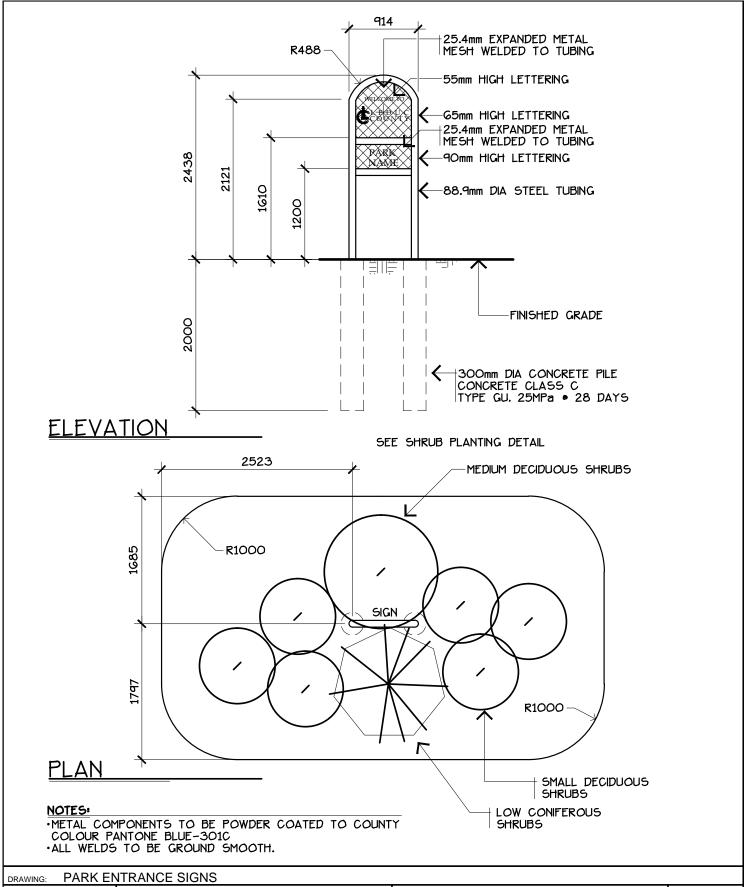

DRAWING. I AITI LI	THATIOL	010110				
	REVISION NO:			DATE:	2009 08	DRAWING NO.
LEDUC	DRAWN BY:	EARTHSCAPE C	CONSULTANTS	SCALE:	1:50	450
LEDUC	CHECKED:	N.M.		APPROVED:	D.O.	15-3
LEDUC COUNTY F	PARKS AN	ID RECREATION	SUITE 101, 11	01 - 5th STREET,	NISKU, ALBERTA, T9E 2X3	

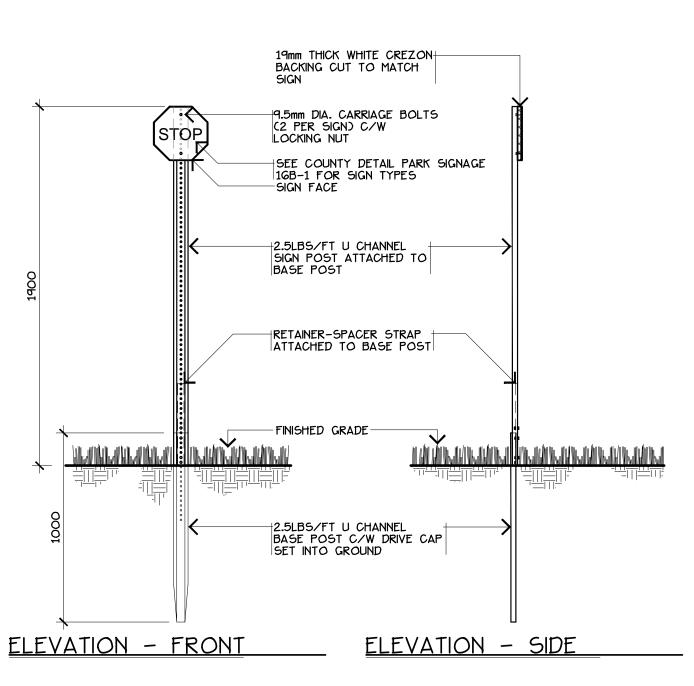

SIGN POSTS TO BE "EZE-ERECT" SIGN POSTS C/W BASE POST SIGN POST. RETAINER-SPACER STRAP AND ALL HARDWARE AS PER MANUFACTURER'S SPECIFICATIONS.


- "EZE-ERECT" SIGN POSTS AVAILABLE FROM ALBERTA TRAFFIC SUPPLY LTD.
- *ALL METAL COMPONENTS TO GALVANIZED. *INSTALL *EZE-ERECT SIGN POSTS ACCORDING TO MANUFACTURER'S **SPECIFICATIONS**

PARK SIGNAGE DRAWING:



16A-1

DRAWING NO.

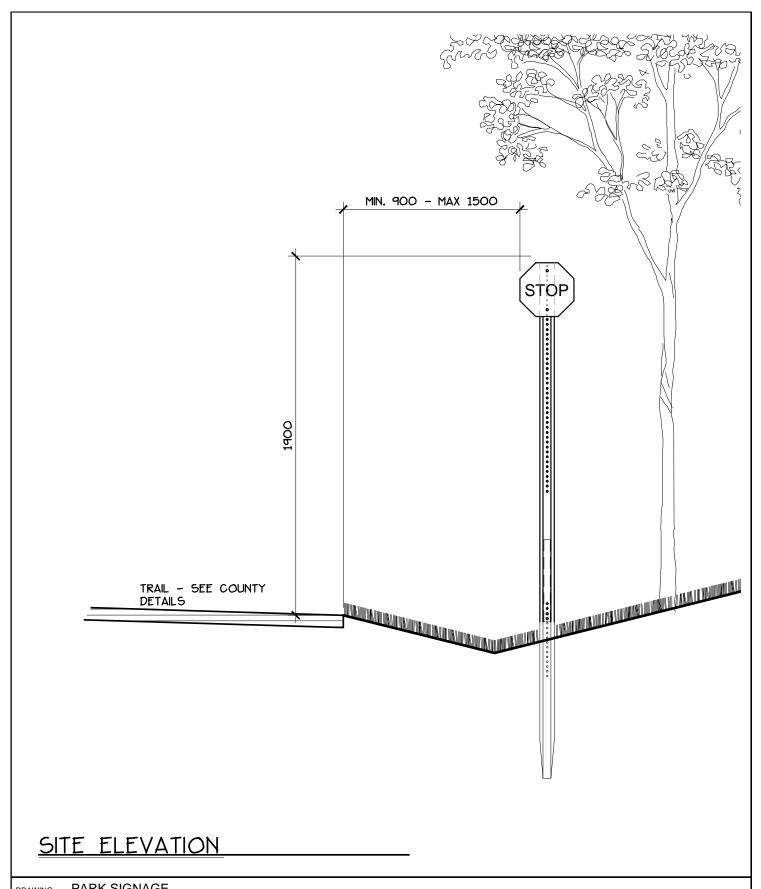

	DRAWING: PARK SI	GNAGE					
ſ	O COLOR	REVISION NO:			DATE:	2009 08	DRAWING NO.
	LEDUC	DRAWN BY:	EARTHSCAPE C	CONSULTANTS	SCALE:	1:20	4040
	COUNTY	CHECKED:	N.M.		APPROVED:	D.O.	16A-2
	LEDUC COUNTY F	PARKS AN	ID RECREATION	SUITE 101, 110)1 - 5th STREET,	NISKU, ALBERTA, T9E 2X3	



300mm x 300mm W/R - HI SIGN GRADE ALUMINIUM - 2mm/.081 9.5mm HOLES, LARGE CROPPED CORNERS



300mm x 300mm B/Y - HI SIGN GRADE ALUMINIUM - 2mm/.081 9.5mm HOLES, CENTERED CROPPED CORNERS



 $375 \text{mm} \times 375 \text{mm} \times 375 \text{mm}$ W/R - HI SIGN GRADE ALUMINIUM - 2mm/.081 TRIANGLE 9.5mm HOLES CENTERED - LARGE CROPPED CORNERS



300mm x 300mm R/B/Y - HI SIGN GRADE ALUMINIUM - 2mm/.081 DIA. 9.5mm HOLES CENTERED - CROPPED



300mm x 300mm R/B/Y - HI SIGN GRADE ALUMINIUM - 2mm/.081 RECT - 9.5mm CENTERED CROPPED CORNERS



200mm x 300mm G/B/W - HI SIGN GRADE ALUMINIUM - 2mm/.081 RECT - 9.5mm CENTERED CROPPED CORNERS



200mm x 300mm W/BR - HI SIGN GRADE ALUMINIUM - 2mm/.081 CROPPED CORNERS



300mm x 200mm W/BR - HI SIGN GRADE ALUMINIUM - 2mm/.081 RECT - 9.5mm CENTERED SQUARE - 9.5mm CENTERED LARGE CROP



300mm x 300mm B/Y - HI SIGN GRADE ALUMINIUM - 2mm/.081 DIA. 9.5mm HOLES ON CENTRE LARGE CROP



HP-8R 300mm x 300mm B/Y - HI SIGN GRADE ALUMINIUM - 2mm/.081 DIA. 9.5mm HOLES ON CENTRE LARGE CROP



300mm x 300mm B/Y - HI SIGN GRADE ALUMINIUM - 2mm/.081 DIA. 9.5mm HOLES ON CENTRE LARGE CROP



300mm x 300mm B/Y - HI SIGN GRADE ALUMINIUM - 2mm/.081 DIA. 9.5mm HOLES ON CENTRE LARGE CROP



300mm x 200mm W/BR - HI SIGN GRADE ALUMINIUM - 2mm/.081 RECT - 9.5mm CENTERED LARGE CROP



300mm x 200mm W/BR - HI SIGN GRADE ALUMINIUM - 2mm/.081 RECT - 9.5mm CENTERED LARGE CROP



HP-14 300mm x 300mm



HP-15 300mm x 300mm



HP-16 300mm x 200mm



300mm x 300mm



300mm x 450mm R/B/Y - HI SIGN GRADE ALUMINIUM - 2mm/.081 RECT - 9.5mm CENTERED CROPPED CORNERS

NOTES:

·SEE DETAIL 1GA-1 AND 1GA-2 FOR SIGN ATTACHMENT AND INSTALLATION SPECIFICATIONS.

SIGN ELEVATIONS

DRAWING: FAIL SIGNAGE	DRAWING:	PARK	SIGNAGE
-----------------------	----------	------	---------

DIGWING. 17th CO	0.00				_
	REVISION NO:		DATE:	2009 08	I
LEDUC	DRAWN BY:	EARTHSCAPE CONSULTANTS	SCALE:	1:20]
LEDUC	CHECKED:	N.M.	APPROVED:	D.O.]
	0.4.0.4.4	ID DECDEATION			1

LEDUC COUNTY PARKS AND RECREATION

SUITE 101, 1101 - 5th STREET, NISKU, ALBERTA, T9E 2X3

DRAWING NO.

16B-1







450mm x 600mm HIGH INTENSITY

450mm x GOOmm HIGH INTENSITY

450mm x GOOmm HIGH INTENSITY

HIGH WATER LEVEL

THE BASE OF THIS SIGN POST INDICATES THE DESIGN HIGH WATER LEVEL FOR THIS LAKE. THE BOTTOM OF THIS SIGN IS 2 METERS FROM THE BASE OF THIS POST.



G10mm x G10mm HIGH INTENSITY




G10mm x 7G2mm HIGH INTENSITY

NOTES:

•SEE DETAIL 16A-1 AND 16A-2 FOR SIGN ATTACHMENT AND INSTALLATION SPECIFICATIONS.

SIGN ELEVATIONS

DR	AWING: PARK SI	GNAGE					
1		REVISION NO:			DATE:	2009 08	DRAWING NO.
	LEDUC	DRAWN BY:	EARTHSCAPE CC	NSULTANTS	SCALE:	1:20	400 0
	COUNTY	CHECKED:	N.M.		APPROVED:	D.O.	16B-2
LE	DUC COUNTY F	PARKS AN	ID RECREATION	SUITE 101, 1101	- 5th STREET, I	NISKU, ALBERTA, T9E 2X3	

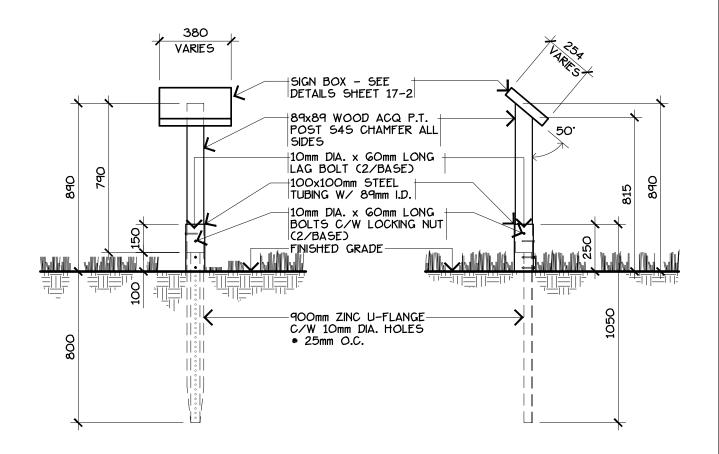


ELEVATION - FRONT

ELEVATION - SIDE


NOTES:

- ·ALL WOOD TO BE ALLOWED TO WEATHER
- •TOUCH UP STAIN AFTER CONSTRUCTION.
- *FIELD TREAT ALL CUT ENDS AND DRILLED HOLES W/ 2 COATS CLEAR ACQ (PRESSURE TREATED WOOD ONLY).
- ·ALL METAL HARDWARE TO BE GALVANIZED.


PARK INTERPRETIVE SIGNS DRAWING: DRAWING NO. REVISION NO: DATE: 2009 08 EDUC EARTHSCAPE CONSULTANTS 1:20 DRAWN BY: SCALE: 17-1 COUNTY CHECKED: N.M. D.O. APPROVED: EDUC COUNTY PARKS AND RECREATION SUITE 101, 1101 - 5th STREET, NISKU, ALBERTA, T9E 2X3

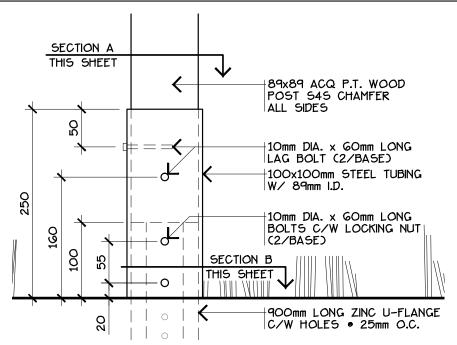


SIGN BASE FRONT VIEW

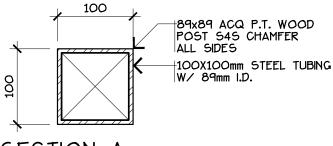

<u>SECTION</u>

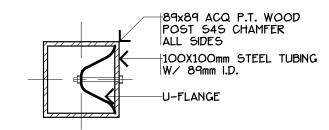


SECTION B

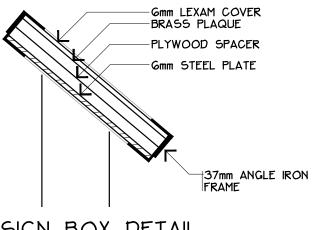

SIGN BOX DETAIL

DRAWING: PARK IN	TERPRET	IVE SIGNS				
	REVISION NO:			DATE:	2009 08	DRAWING NO.
LEDUC COUNTY	DRAWN BY:	EARTHSCAPE CONS	ULTANTS	SCALE:	1:5] , , ,
COUNTY	CHECKED:	N.M.		APPROVED:	D.O.] 17-2
LEDUC COUNTY F	PARKS AN	ID RECREATION	SUITE 101, 1101	- 5th STREET, I	NISKU, ALBERTA, T9E 2X3	7

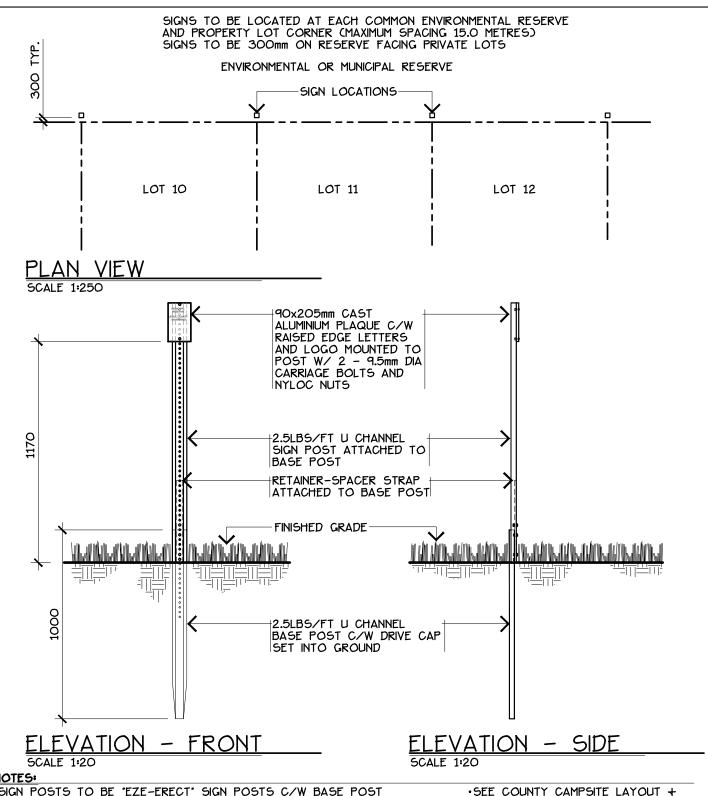

•SIGN POSTS TO BE "EZE-ERECT" SIGN POSTS C/W BASE POST SIGN POST. RETAINER-SPACER STRAP AND ALL HARDWARE AS PER MANUFACTURER'S SPECIFICATIONS.

•SEE COUNTY CAMPSITE LAYOUT + SURFACING DETAILS FOR CAMPSITE DESIGNATION SIGN LOCATIONS

DRAWING NO.


18-1

- "EZE-ERECT" SIGN POSTS AVAILABLE FROM ALBERTA TRAFFIC SUPPLY LTD.
 •ALL METAL COMPONENTS TO GALVANIZED.
 •INSTALL "EZE-ERECT" SIGN POSTS ACCORDING TO MANUFACTURER'S
- **SPECIFICATIONS**

ER/MR AND CAMPSITE DESIGNATION SIGNS DRAWING:

REVISION NO: DATE: 2009 08 EARTHSCAPE CONSULTANTS EDUC DRAWN BY: AS NOTED SCALE: COUNTY N.M. D.O. CHECKED: APPROVED: EDUC COUNTY PARKS AND RECREATION SUITE 101, 1101 - 5th STREET, NISKU, ALBERTA, T9E 2X3



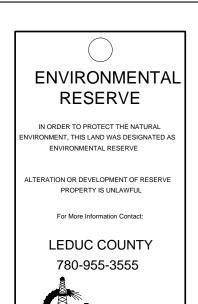

REMOVAL OF THIS SIGN IS PROHIBITED BY-LAW 26-98

CAMPGROUND
NAME
STALL NUMBER

LEDUC COUNTY
780-955-3555

ELEVATIONS

	DRAWING: ER/MR A	ND CAME	PSITE DESIGNATIO	N SIGNS			
I		REVISION NO:			DATE:	2009 08	DRAWING NO.
l	LEDUC	DRAWN BY:	EARTHSCAPE CO	NSULTANTS	SCALE:	1:2] 40 0
l	COUNTY	CHECKED:	N.M.		APPROVED:	D.O.] 18-2
ſ	LEDUC COUNTY F	PARKS AN	ID RECREATION	SUITE 101, 1101	- 5th STREET, I	NISKU, ALBERTA, T9E 2X3	7






450mm x GOOmm HIGH INTENSITY

450mm x GOOmm HIGH INTENSITY

SIGN ELEVATION

DRAWING: PARK AF	<u>₹EA ACTI\</u>	VITY SIGNS				
	REVISION NO:			DATE:	2009 08	DRAWING NO.
	DRAWN BY:	EARTHSCAPE CON	NSULTANTS	SCALE:	1:5	40
COUNTY	CHECKED:	N.M.		APPROVED:	D.O.	19
LEDUC COUNTY F	ARKS AN	ID RECREATION	SUITE 101, 1101	- 5th STREET, I	NISKU, ALBERTA, T9E 2X3	

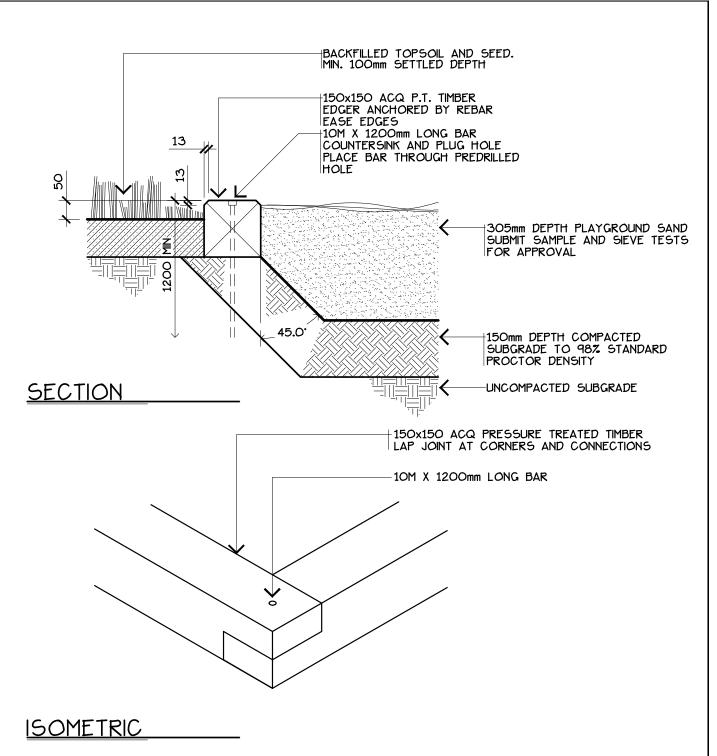

•FIELD TREAT ALL CUT ENDS, DRILLED HOLES AND EASED EDGES W/ 2 COATS CLEAR ACQ.

PLAYGROUND EDGER DRAWING: DRAWING NO. REVISION NO: DATE: 2009 08 EARTHSCAPE CONSULTANTS 1:10 EDUC DRAWN BY: SCALE: 19A COUNTY CHECKED: N.M. D.O. APPROVED: LEDUC COUNTY PARKS AND RECREATION SUITE 101, 1101 - 5th STREET, NISKU, ALBERTA, T9E 2X3

Play Safe

This playground is designed for ages 18 months to 5 years Adult Supervision is Always Recommended

Pets are not permitted on the equipment or in the sand area.

This Playspace is checked regularly by Parks Staff. Should you see damage or vandalism please call 780-955-3555

300mm x 350mm BLACK ON WHITE - HI SIGN GRADE ALUMINUM - 2mm/.081

RECT - 9.5mm CENTERED CROPPED CORNERS

Play Safe

This playground is designed for ages 5 years to 12 years Adult Supervision is Always Recommended

Pets are not permitted on the equipment or in the sand area.

This Playspace is checked regularly by Parks Staff. Should you see damage or vandalism please call 780-955-3555

300mm x 350mm BLACK ON WHITE - HI SIGN GRADE ALUMINUM - 2mm/.081 RECT - 9.5mm CENTERED CROPPED CORNERS

Play Safe

This playground is designed for ages 18 months to 12 years Adult Supervision is Always Recommended

Pets are not permitted on the equipment or in the sand area.

This Playspace is checked regularly by Parks Staff. Should you see damage or vandalism please call 780-955-3555

300mm x 350mm BLACK ON WHITE - HI SIGN GRADE ALUMINUM - 2mm/.081 RECT - 9.5mm CENTERED CROPPED CORNERS


NOTES:

- PLAYGROUND SIGNS TO BE LOCATED AT ALL MAJOR ENTRANCES TO THE PLAYGROUND. LOCATIONS TO BE APPROVED BY LEDUC COUNTY.
- ·SEE PARK SIGNAGE DETAILS 16A-1 AND 16A-2 FOR SIGN MOUNTING DETAILS
- *WHERE POSSIBLE THE SIGNS ARE TO BE MOUNTED TO THE PLAY STRUCTURE IN SAFE AND VISIBLE LOCATIONS. LOCATIONS TO BE APPROVED BY LEDUC COUNTY.

WHERE POSSIBLE THE SIGNS CAN BE ENGRAVED INTO A PANEL ON THE PLAY STRUCTURE IN SAFE AND VISIBLE LOCATIONS. LOCATIONS TO BE APPROVED BY LEDUC COUNTY

PLAYGROUND SIGNAGE DRAWING: DRAWING NO. REVISION NO: DATE: 2009 08 DRAWN BY: **EARTHSCAPE CONSULTANTS** 1:5 EDUC SCALE 19B COUNTY CHECKED: N.M. D.O. APPROVED: EDUC COUNTY PARKS AND RECREATION


SUITE 101, 1101 - 5th STREET, NISKU, ALBERTA, T9E 2X3

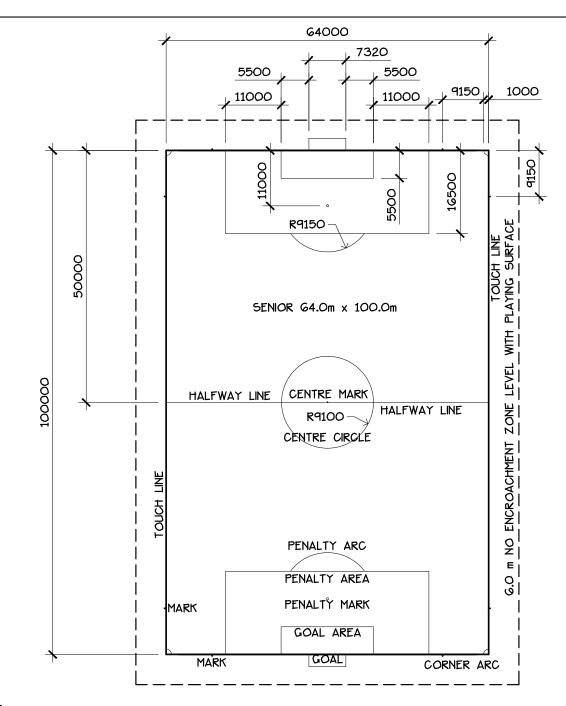

- GRADE AT 1% FROM HALFWAY LINES TO GOALS OR FROM CENTRELINE OF GOALS TO TOUCHLINE
 ALL SOILMIX IN NO ENCROACHMENT ZONE TO BE 3 PARTS TOPSOIL. 1 PART PEAT/COMPOST AND 1 PART MEDIUM SAND
 INSTALL SPORT FIELD REFERENCE LAYOUT PINS AT TIME OF CONSTRUCTION USING 500mm LENGTHS OF 15M REBAR
 AT MINIMUM DEPTH OF 50mm BELOW GRADE.
 PREFERED ORIENTATION OF FIELDS IS A NORTH TO SOUTH DIRECTION. SITE CONDITIONS MAY DICTATE AN ALTERNATIVE.
 SEED IN ACCORDANCE WITH SEED AND SOD DETAIL 13B WITH A PARK SEED MIX.
- · SOILMIX DEPTH 100mm SETTLED DEPTH.

PLAN VIEW


DRAWING: SENIOR	SOCCER	FIELD				
	REVISION NO:			DATE:	2009 08	DRAWING NO.
LEDUC COUNTY	DRAWN BY:	EARTHSCAPE CON	ISULTANTS	SCALE:	1:750	00 1
COUNTY	CHECKED:	N.M.		APPROVED:	D.O.	20A
LEDUC COUNTY F	PARKS AN	ID RECREATION	SUITE 101, 1101	- 5th STREET, I	NISKU, ALBERTA, T9E 2X3	

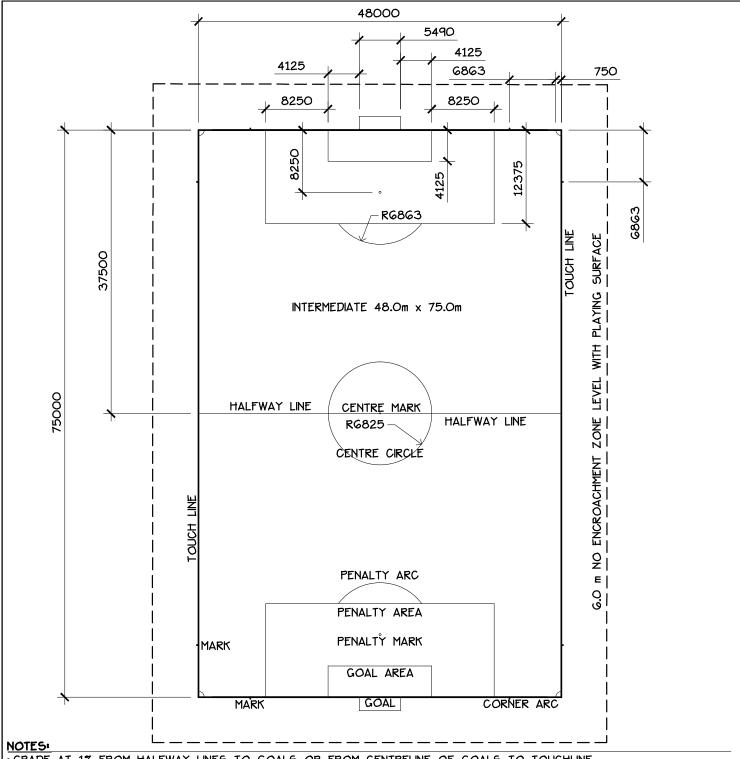

• GRADE AT 1% FROM HALFWAY LINES TO GOALS OR FROM CENTRELINE OF GOALS TO TOUCHLINE
• ALL SOILMIX IN NO ENCROACHMENT ZONE TO BE 3 PARTS TOPSOIL. 1 PART PEAT/COMPOST AND 1 PART MEDIUM SAND
• INSTALL SPORT FIELD REFERENCE LAYOUT PINS AT TIME OF CONSTRUCTION USING 500mm LENGTHS OF 15M REBAR
AT MINIMUM DEPTH OF 50mm BELOW GRADE.

• PREFERRED ORIENTATION OF FIELDS IS A NORTH TO SOUTH DIRECTION. SITE CONDITIONS MAY DICTATE AN ALTERNATIVE.
• SEED IN ACCORDANCE WITH SEED AND SOD DETAIL 13B WITH A PARK SEED MIX.
• SOILMIX DEPTH - 100mm SETTLED DEPTH.


DRAWING: INTERM	<u>=DIATE S</u>	OCCER FIELD				
	REVISION NO:	:		DATE:	2009 08	DRAWING NO.
LEDUC	DRAWN BY:	EARTHSCAPE CONS	ULTANTS	SCALE:	1:500	000
COUNTY	CHECKED:	N.M.		APPROVED:	D.O.	20B
LEDUC COUNTY F	PARKS AL	ND RECREATION	SUITE 101 1101	- 5th STREET I	NISKII ALBERTA TOE 2Y3	1

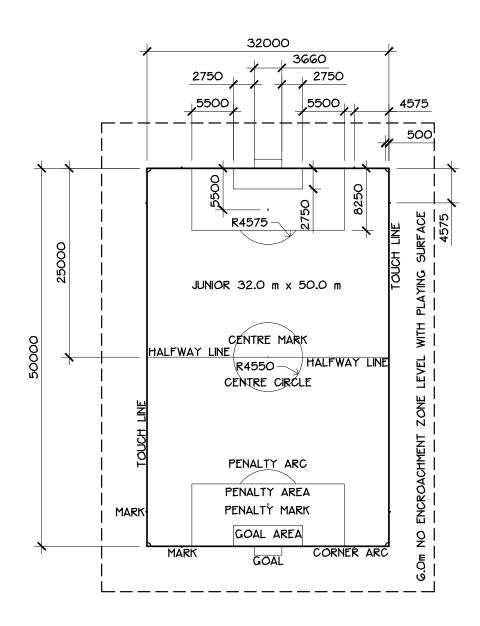


- GRADE AT 1% FROM HALFWAY LINES TO GOALS OR FROM CENTRELINE OF GOALS TO TOUCHLINE
 ALL SOILMIX IN NO ENCROACHMENT ZONE TO BE 3 PARTS TOPSOIL. 1 PART PEAT/COMPOST AND 1 PART MEDIUM SAND
 INSTALL SPORT FIELD REFERENCE LAYOUT PINS AT TIME OF CONSTRUCTION USING 500mm LENGTHS OF 15M REBAR
 AT MINIMUM DEPTH OF 50mm BELOW GRADE.
- PREFERRED ORIENTATION OF FIELDS IS A NORTH TO SOUTH DIRECTION. SITE CONDITIONS MAY DICTATE AN ALTERNATIVE. SEED IN ACCORDANCE WITH SEED AND SOD DETAIL 13B WITH A PARK SEED MIX. SOILMIX DEPTH 100mm SETTLED DEPTH.

PLAN VIEW

DRAWING: JUNIOR	SOCCER	FIELD				
	REVISION NO:			DATE:	2009 08	DRAWING NO.
		EARTHSCAPE CON	NSULTANTS	SCALE:	1:500	000
COUNTY	CHECKED:	N.M.		APPROVED:	D.O.	20C
LEDUC COUNTY F	PARKS AN	ND RECREATION	SUITE 101, 1101	- 5th STREET, I	NISKU, ALBERTA, T9E 2X3	

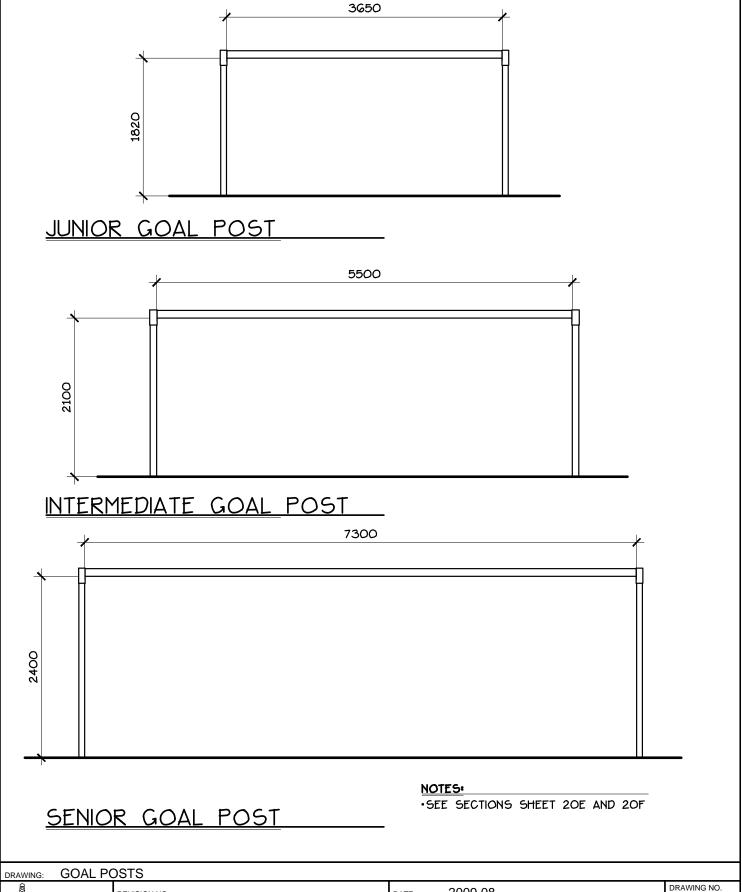

DRAWING: GOAL F	2010							
	REVISION NO:			DATE:	2009 08		DRAWING NO.	
LEDUC	DRAWN BY:	EARTHSCAPE C	ONSULTANTS	SCALE:	1:50		000	
COUNTY	CHECKED:	N.M.		APPROVED:	D.O.		200	
LEDUC COUNTY PARKS AND RECREATION SUITE 101, 1101 - 5th STREET, NISKU, ALBERTA, T9E 2X3								

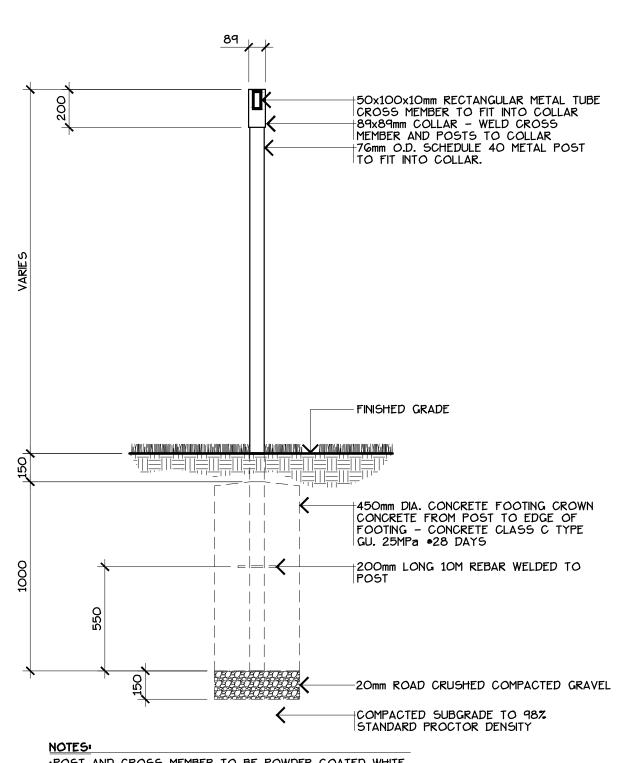

- POST AND CROSS MEMBER TO BE POWDER COATED WHITE ALL CONNECTIONS TO BE WELDED AND GROUND SMOOTH


SECTION

GOAL POST - PERMANENT DRAWING:

	REVISION NO:			DATE:	2009 08]
LEDUC	DRAWN BY:	EARTHSCAPE CONS	SULTANTS	SCALE:	1:20]
LEDUC COUNTY	CHECKED:	N.M.		APPROVED:	D.O.]
LEDUC COUNTY F	PARKS AN	ID RECREATION	SUITE 101, 1101	- 5th STREET, I	NISKU, ALBERTA, T9E 2X3	1

20E


DRAWING NO.

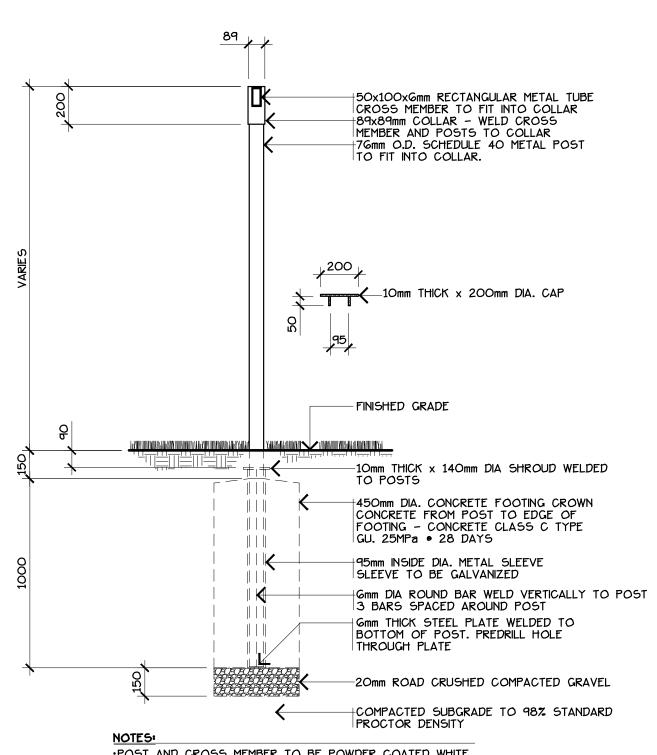


POST AND CROSS MEMBER TO BE POWDER COATED WHITE ALL CONNECTIONS TO BE WELDED AND GROUND SMOOTH


SECTION

	DRAWING: GOAL PO	OST W/ SI	EEVE					
Γ		REVISION NO:			DATE:	2009 08		DRAWING NO.
	LEDUC COUNTY	DRAWN BY:	EARTHSCAPE CON	SULTANTS	SCALE:	1:20		
	COUNTY	CHECKED:	N.M.		APPROVED:	D.O.] 20F
LEDUC COUNTY PARKS AND RECREATION SHITE 101 1101 - 5th STREET, NISKIL ALBERTA, TOP 2X3								

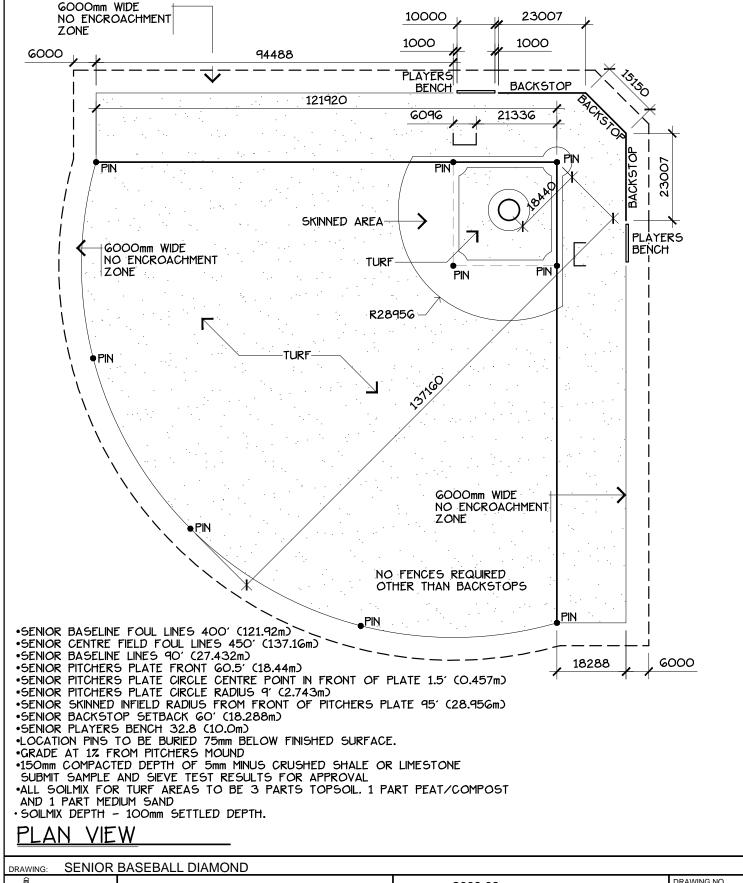


	REVISION NO:			DATE:	2009 08	DRAWING NO.
169 M	DRAWN BY:	EARTHSCAPE CON	NSULTANTS	SCALE:	1:1000	
COUNTY	CHECKED:	N.M.		APPROVED:	D.O.	21A-1
LEDUC COUNTY F	PARKS AN	ID RECREATION	SUITE 101, 1101	- 5th STREET, I	NISKU, ALBERTA, T9E 2X3	

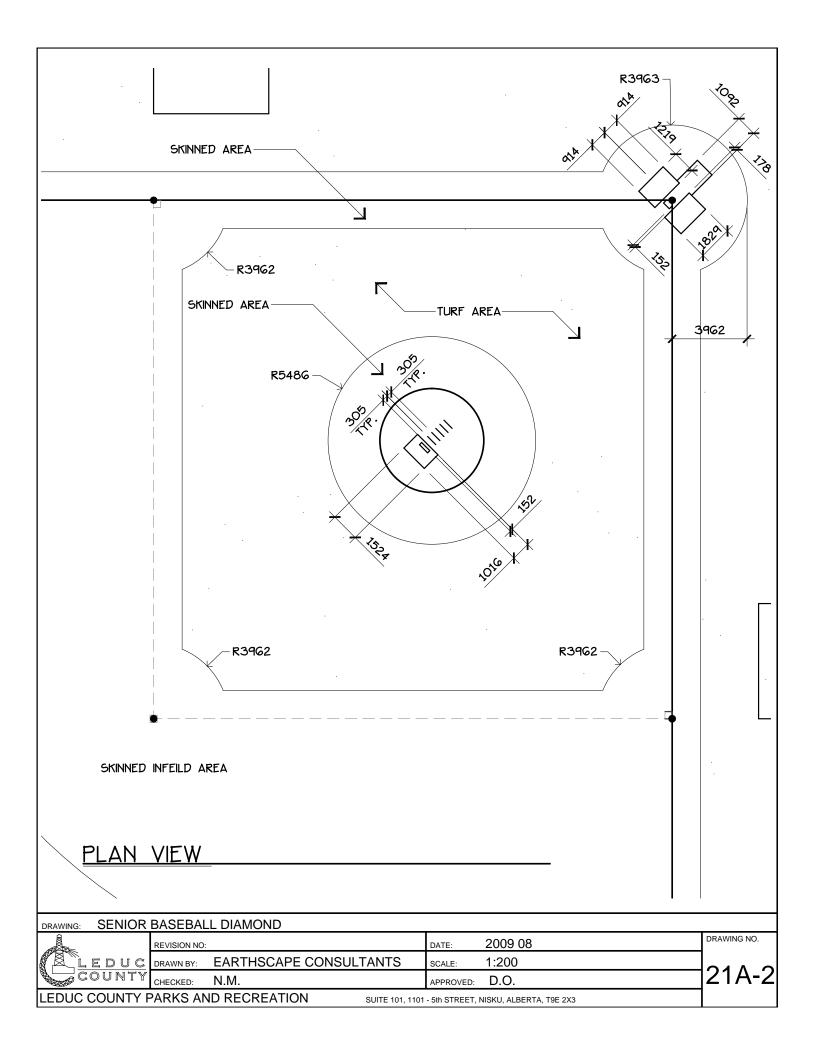

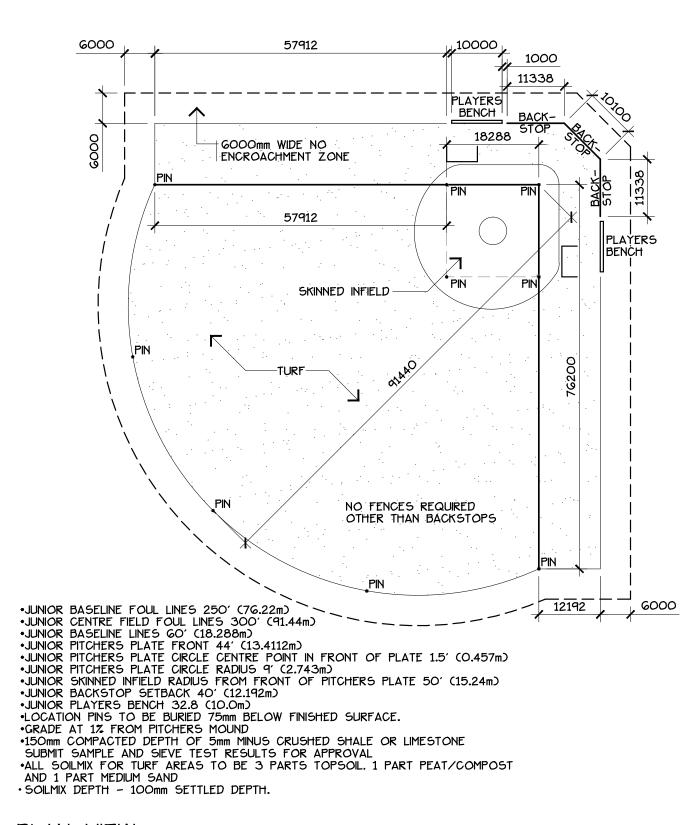


PLAN VIEW


DRAWING: LITTLE LEAGUE BASEBALL DIAMOND DRAWING NO. REVISION NO: DATE: 2009 08 EARTHSCAPE CONSULTANTS EDUC DRAWN BY: 1:750 SCALE: 21B-1 COUNTY N.M. D.O. CHECKED: APPROVED: EDUC COUNTY PARKS AND RECREATION SUITE 101, 1101 - 5th STREET, NISKU, ALBERTA, T9E 2X3

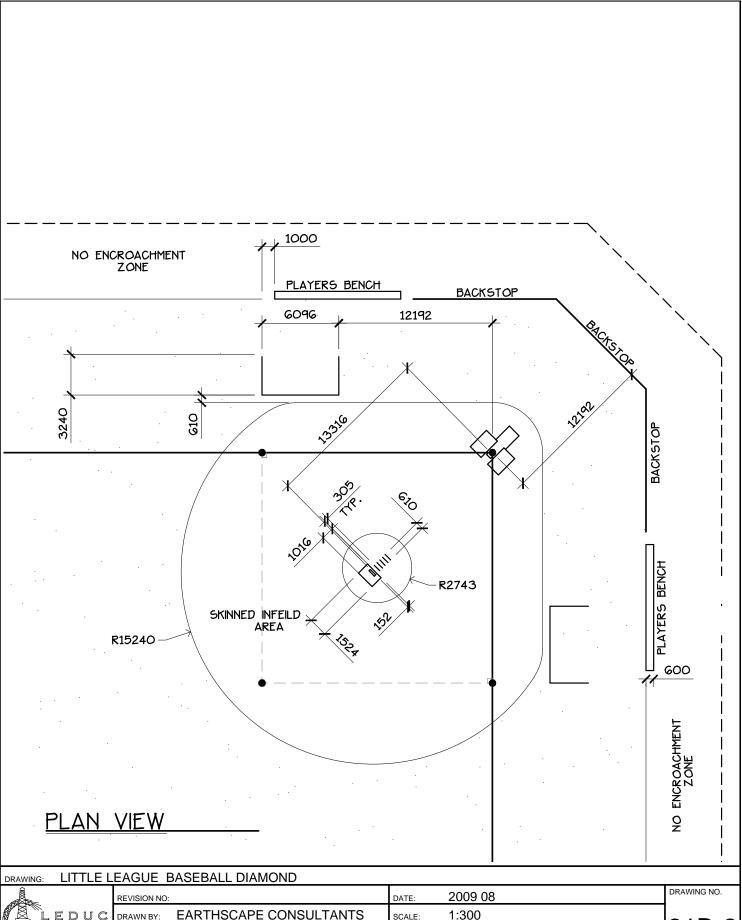


DRAWING: LIIILE L	EAGUE	SASEBALL DIAM	OND			
O CONTRACTOR OF THE CONTRACTOR	REVISION NO:			DATE:	2009 08	DRAWING NO.
LEDUC	DRAWN BY:	EARTHSCAPE (CONSULTANTS	SCALE:	1:300	040 0
COUNTY	CHECKED:	N.M.		APPROVED:	D.O.]21B-2
LEDUC COUNTY F	PARKS AN	ID RECREATION	SUITE 101, 110)1 - 5th STREET,	NISKU, ALBERTA, T9E 2X3	

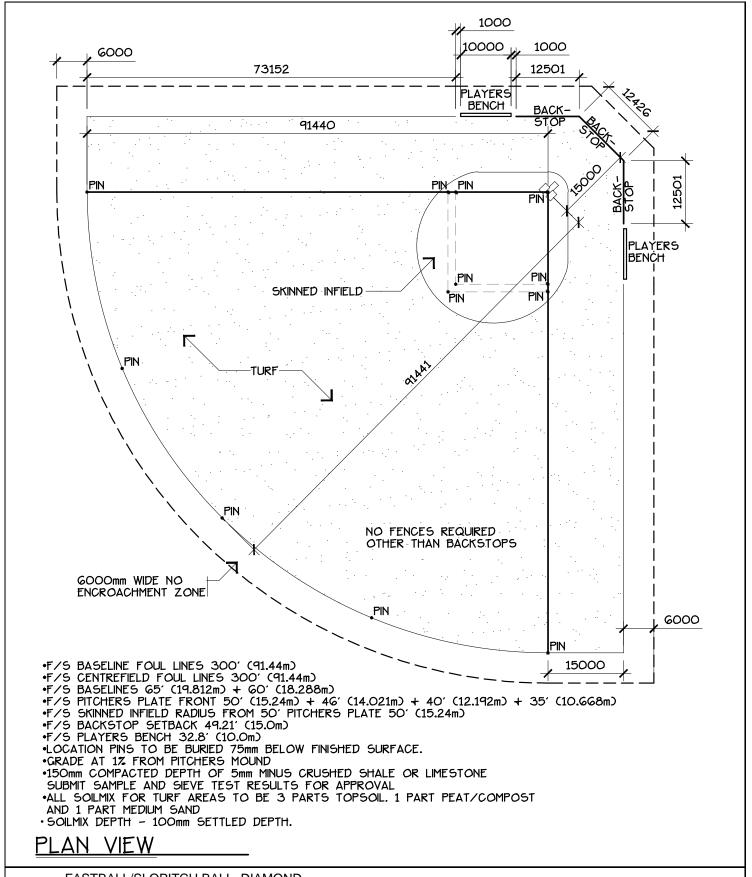


FASTBALL/SLOPITCH BALL DIAMOND DRAWING NO. REVISION NO: DATE: 2009 08 1:7<u>50</u> EARTHSCAPE CONSULTANTS EDUC DRAWN BY: SCALE: 21C-COUNTY N.M. D.O. CHECKED: APPROVED: EDUC COUNTY PARKS AND RECREATION SUITE 101, 1101 - 5th STREET, NISKU, ALBERTA, T9E 2X3

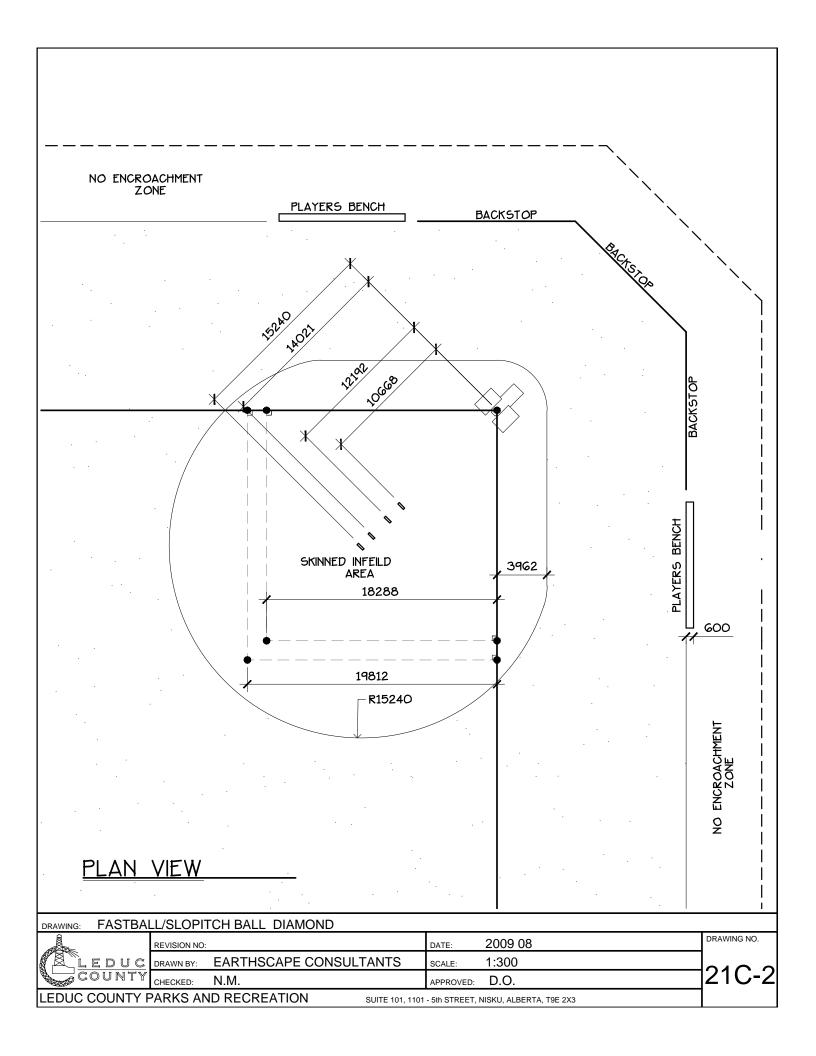

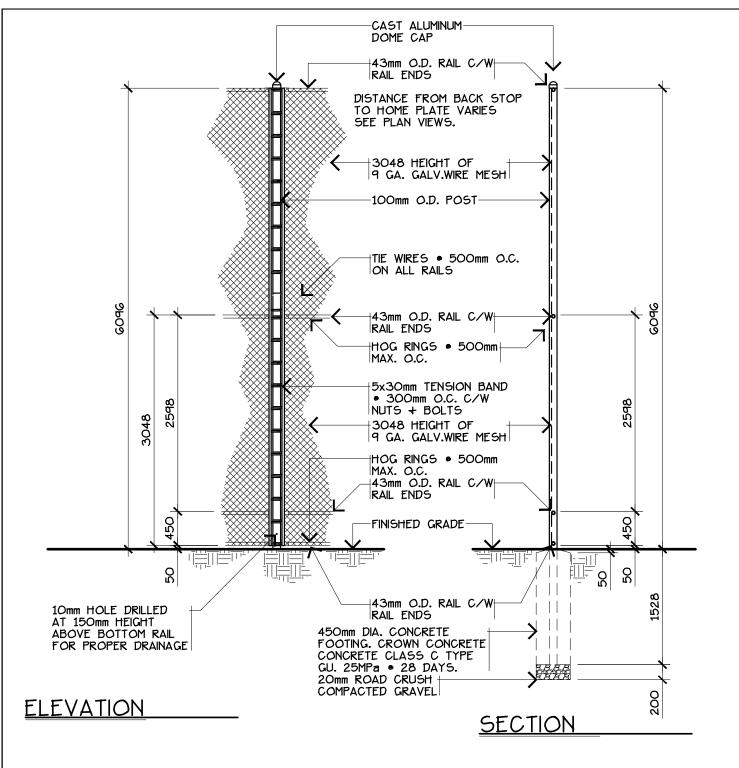



- •POSTS: 100mm O.D. SCHEDULE 40 ZINC COATED GRADE 1 MIN. 550g/m2 •RAILS: 43mm O.D. SCHEDULE 40 ZINC COATED GRADE 1 MIN. 550g/m2 •FABRIC: TYPE 1 MEDIUM STYLE 50mm 9 GAUGE CLASS A ZINC-COATED GRADE 1 MIN. 490g/m2. TWISTED TOP, KNUCKLE BOTTOM

BACKSTOP DETAILS DRAWING:

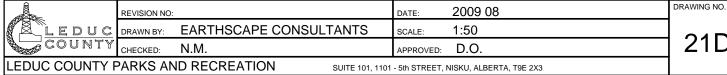

21D

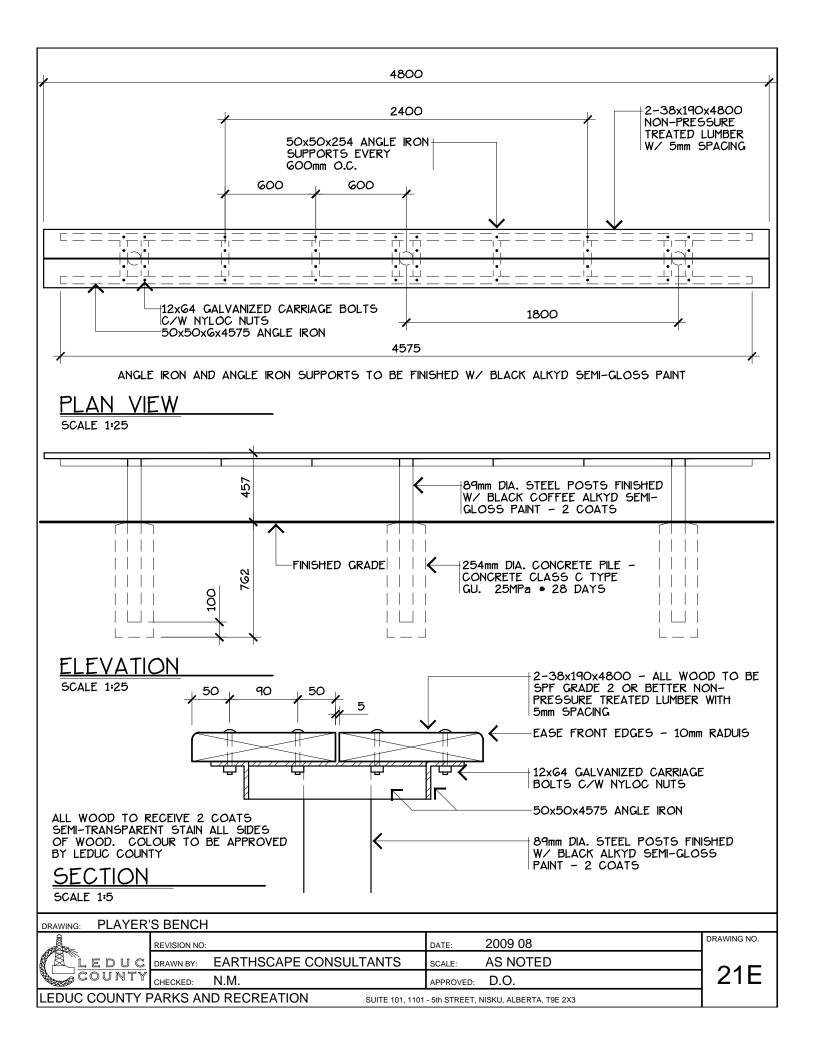

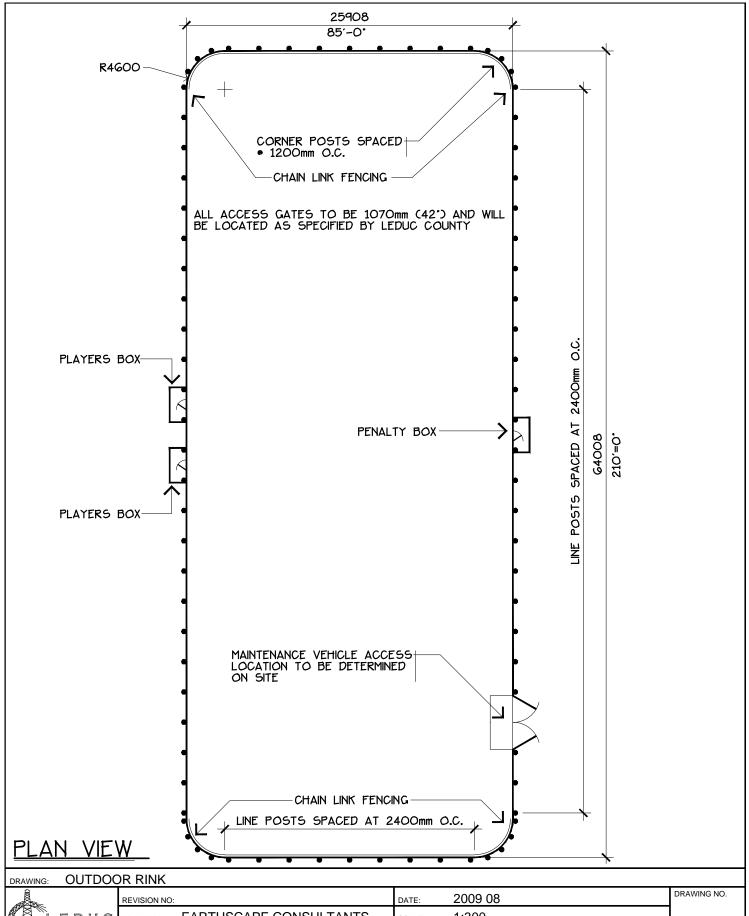


REVISION NO: DATE: 2009 08

LEDUC DRAWN BY: EARTHSCAPE CONSULTANTS SCALE: 1:300

CHECKED: N.M. APPROVED: D.O.


LEDUC COUNTY PARKS AND RECREATION SUITE 101, 1101 - 5th STREET, NISKU, ALBERTA, T9E 2X3


22-1

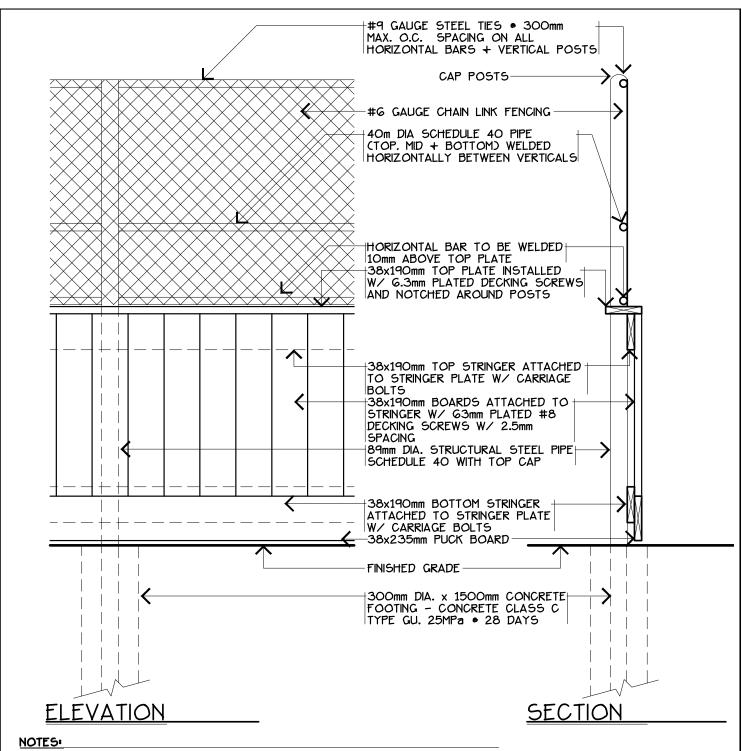


- ALL BOARDS TO BE PAINTED W/ BEHR PINTO WHITE OR APPROVED EQUAL ALL WELDS TO BE PAINTED W/ ZINC OXIDE. ALL METAL SURFACES TO BE PAINTED W/ TWO COATS OF TREMCLAD FLAT WHITE FOR METAL
- · TENSION BANDS TO BE INSTALLED ON END POSTS AT 500mm O.C. SPACING
- STEEL WIRE TIES ARE TO BE USED. NOT ALUMINUM
 ALL CHAIN LINK COMPONENTS TO BE GALVANIZED UNLESS STATED OTHERWISE


DRAWING: OUTDOO	<u>)r rink</u>					
	REVISION NO:			DATE:	2009 08	DRAWING NO.
LEDUC	DRAWN BY:	EARTHSCAPE CON	NSULTANTS	SCALE:	1:20	
COUNTY	CHECKED:	N.M.		APPROVED:	D.O.	22-2
LEDUC COUNTY F	ARKS AN	ND RECREATION	SUITE 101, 1101	- 5th STREET, I	NISKU, ALBERTA, T9E 2X3	

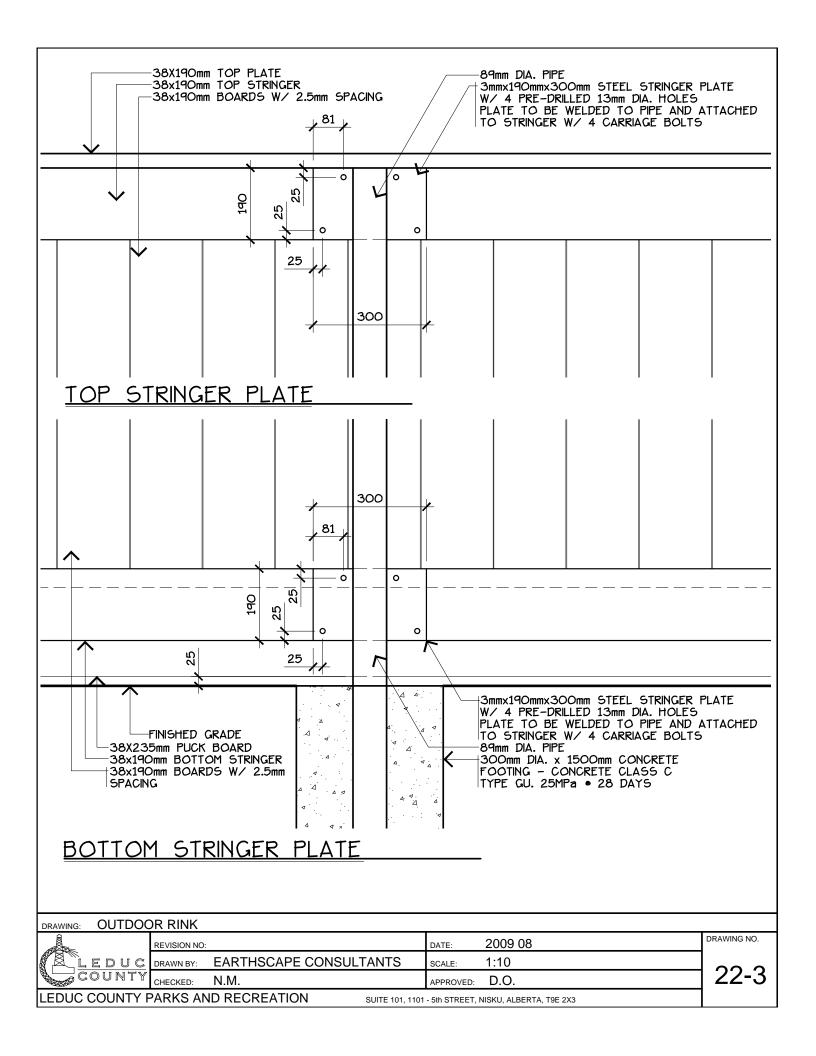


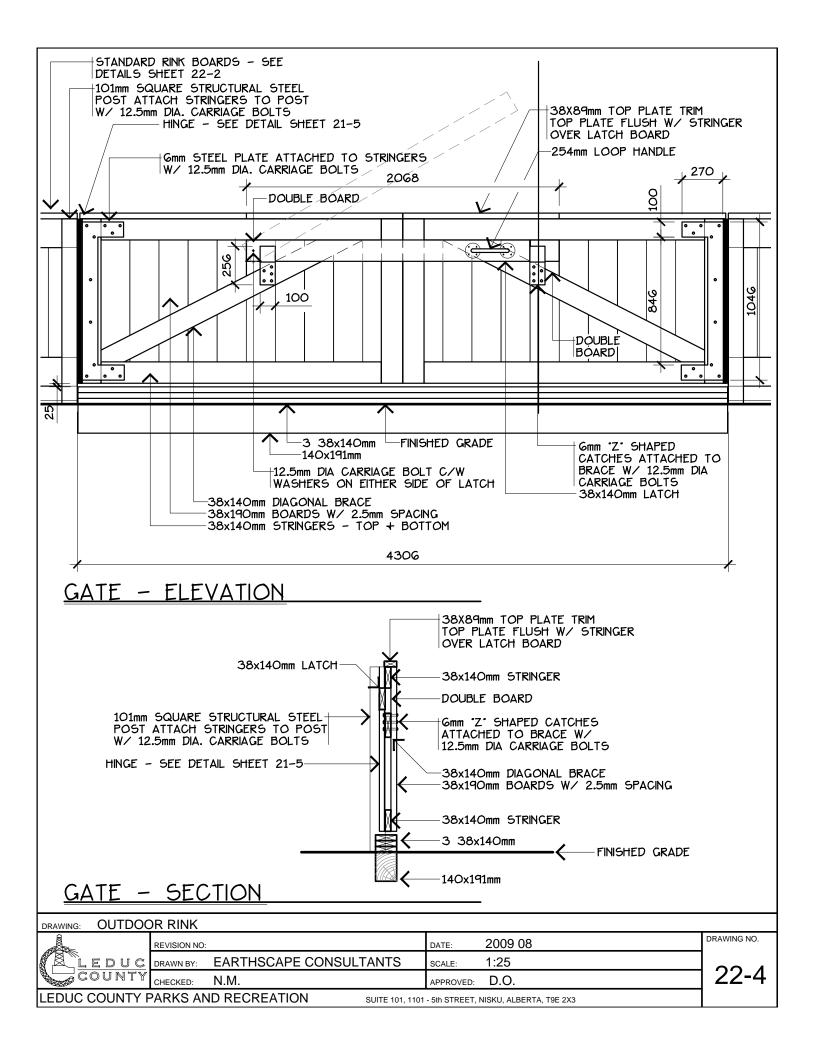

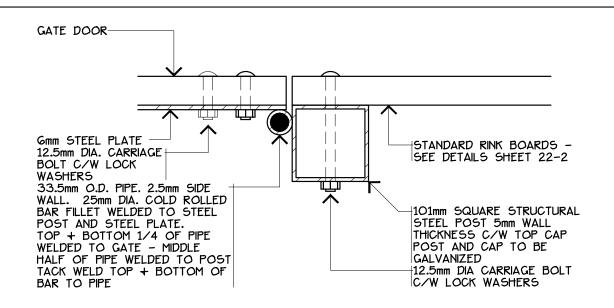

HINGE DETAIL

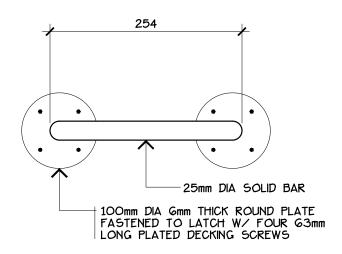

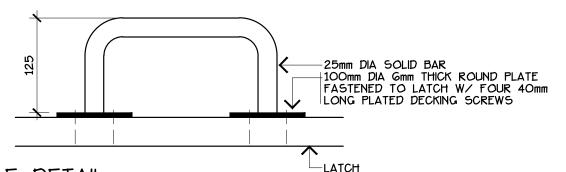


LOOP HANDLE DETAIL

DRAWING:	OUTDOOR	RINK

	REVISION NO:		DATE:	2009 08	Ī
LEDUC COUNTY	DRAWN BY:	EARTHSCAPE CONSULTANTS	SCALE:	1:5]
COUNTY	CHECKED:	N.M.	APPROVED:	D.O.]
LEDUC COUNTY F	PARKS AN	ID RECREATION SUITE 101 110	1 - 5th STREET	NISKII ALBERTA TOE 2Y3	1

22-5


DRAWING NO.

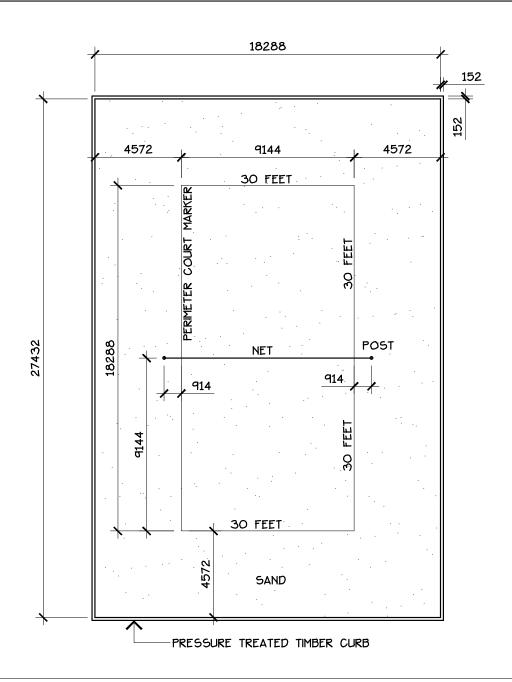

- · MEN'S NET HEIGHT 2.43m
- · WOMEN'S NET HEIGHT 2.24m GRADE AT 1% FROM NET CENTRELINE TO ENDS
- VOLLEYBALL POSTS. NETS AND PERIMETER COURT MARKER AVAILABLE FROM HABITAT SYSTEMS INCORPORATED POSTS TO BE PW ATHLETIC MFG. CO. MODEL #2216-21 POWDER COATED COUNTY BLUE-301C. VOLLEYBALL NET TO BE PW ATHLETIC MFG. CO. MODEL #8361-10 PERIMETER COURT MARKER PORTER 09855-000

PLAN VIEW

SAND VOLLEYBALL COURT DRAWING: DRAWING NO. REVISION NO: DATE: 2009 08 EARTHSCAPE CONSULTANTS 1:200 EDUC DRAWN BY: SCALE: 23-1 COUNTY CHECKED: N.M. D.O. APPROVED: LEDUC COUNTY PARKS AND RECREATION SUITE 101, 1101 - 5th STREET, NISKU, ALBERTA, T9E 2X3

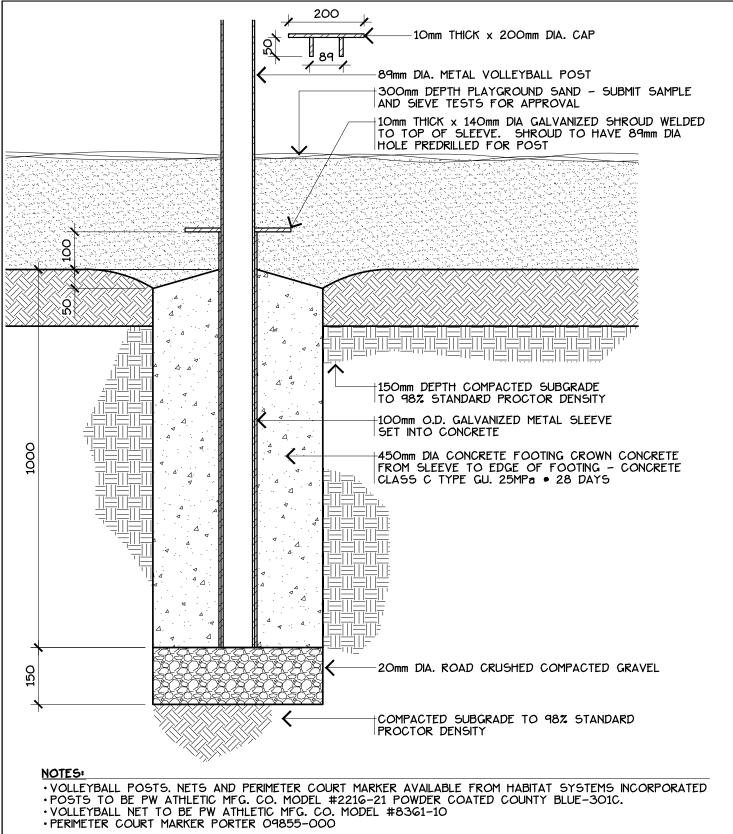


SAND VOLLEYBALL COURT DRAWING: REVISION NO: DATE: 2009 08 EARTHSCAPE CONSULTANTS EDUC DRAWN BY: 1:10 SCALE: COUNTY N.M. D.O. CHECKED: APPROVED:

EDUC COUNTY PARKS AND RECREATION

SUITE 101, 1101 - 5th STREET, NISKU, ALBERTA, T9E 2X3


DRAWING NO.

23-2

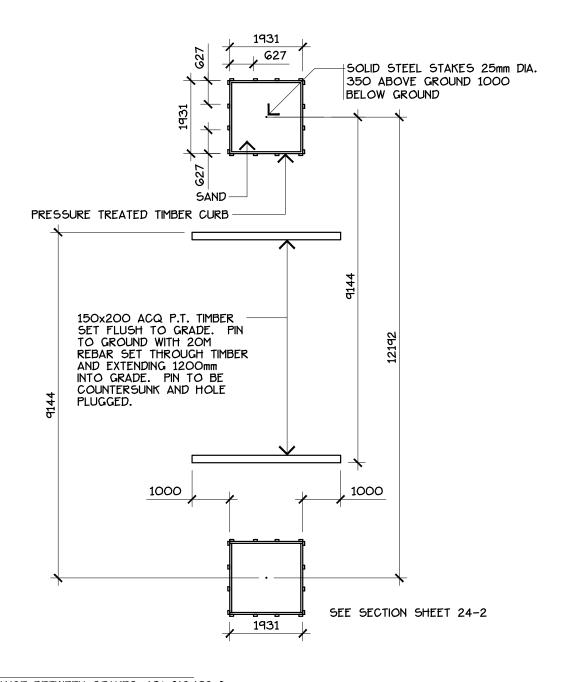

- MEN'S DISTANCE BETWEEN STAKES 40' (12.192m) WOMEN'S DISTANCE BETWEEN STAKES 30'(9.144m)

DRAWING: HORSES	SHOE PITO	CH				
	REVISION NO:			DATE:	2009 08	DRAWING NO.
LEDUC	DRAWN BY:	EARTHSCAPE CO	NSULTANTS	SCALE:	1:100	\Box
	CHECKED:	N.M.		APPROVED:	D.O.	<u> </u>
LEDUC COUNTY F	ARKS AN	ND RECREATION	SUITE 101, 1101	- 5th STREET. I	NISKU. ALBERTA. T9E 2X3	

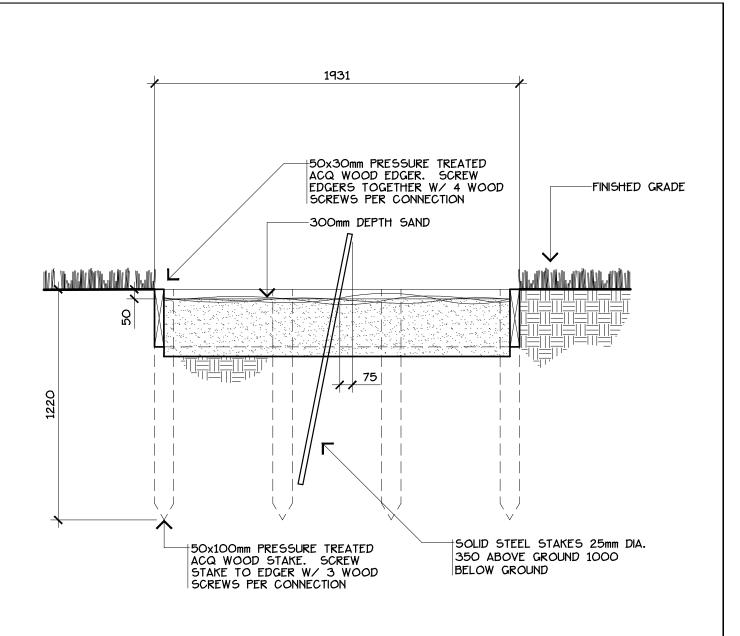


- MEN'S DISTANCE BETWEEN STAKES 40' (12.192m) WOMEN'T DISTANCE BETWEEN STAKES 30'(9.144m)
- •FIELD TREAT ALL CUT ENDS AND DRILLED HOLES


 W/ 2 COATS CLEAR ACQ (PRESSURE TREATED WOOD ONLY).
 •ALL METAL HARDWARE TO BE GALVANIZED.

HORSESHOE PITCH DRAWING: DRAWING NO. REVISION NO: DATE: 2009 08 EARTHSCAPE CONSULTANTS 1:20 EDUC DRAWN BY: SCALE: COUNTY CHECKED: N.M. D.O. APPROVED: LEDUC COUNTY PARKS AND RECREATION SUITE 101, 1101 - 5th STREET, NISKU, ALBERTA, T9E 2X3

24-2

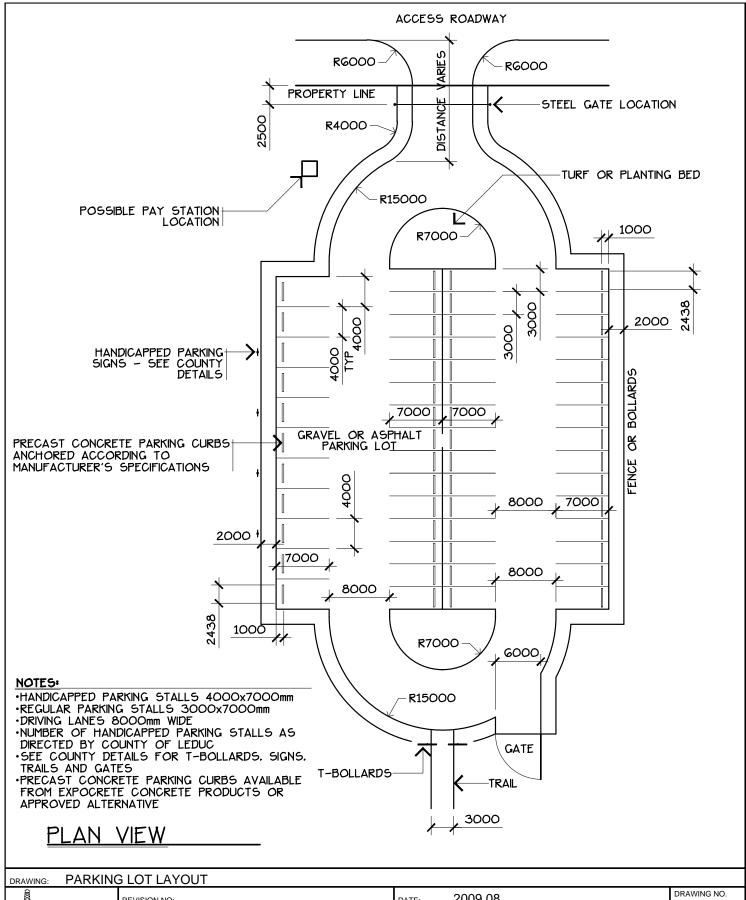

- R		REVISION NO:			DATE:	2009 08		DRAWING NO.
			EARTHSCAPE CONSUL	TANTO		1:500		†
	LEDUC	DRAWN BY:		LIANIS	SCALE:	1.500		25
		CHECKED:	N.M.		APPROVED:	D.O.		
	LEDUC COUNTY F	PARKS AN	ID RECREATION	SUITE 101, 1101	- 5th STREET, I	NISKU, ALBERTA, T9E 2X	3	

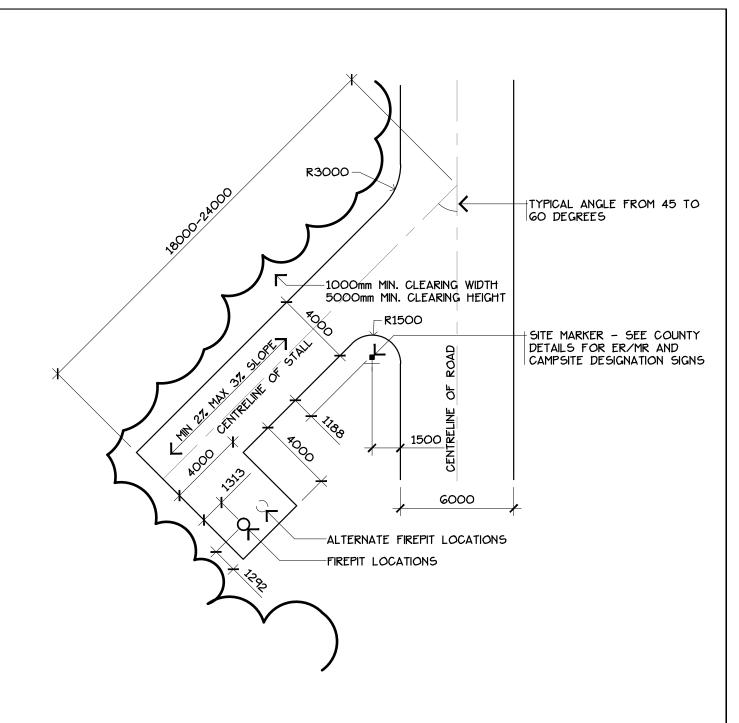

CAMPSITE STALL TO BE GRAVEL SURFACE. 150mm DEPTH 20mm ROAD CRUSH GRAVEL COMPACTED TO 98% STANDARD PROCTOR DENSITY. GRAVEL TO BE PLACED ON 150mm DEPTH COMPACTED SUBGRADE TO 98% STANDARD PROCTOR DENSITY


PLAN VIEW - BACK IN STALL

DRAWING:	CAMPSI	TE LAYOUT AND SURFACING
Δ		


	REVISION NO:		DATE:	2009 08			
LEDUC COUNTY	DRAWN BY:	EARTHSCAPE CONSULTANTS	SCALE:	1:200			
COUNTY	CHECKED:	N.M.	APPROVED:	D.O.			
LEDUC COUNTY PARKS AND RECREATION SUITE 101, 1101 - 5th STREET, NISKU, ALBERTA, T9E 2X3							

26A


DRAWING NO.

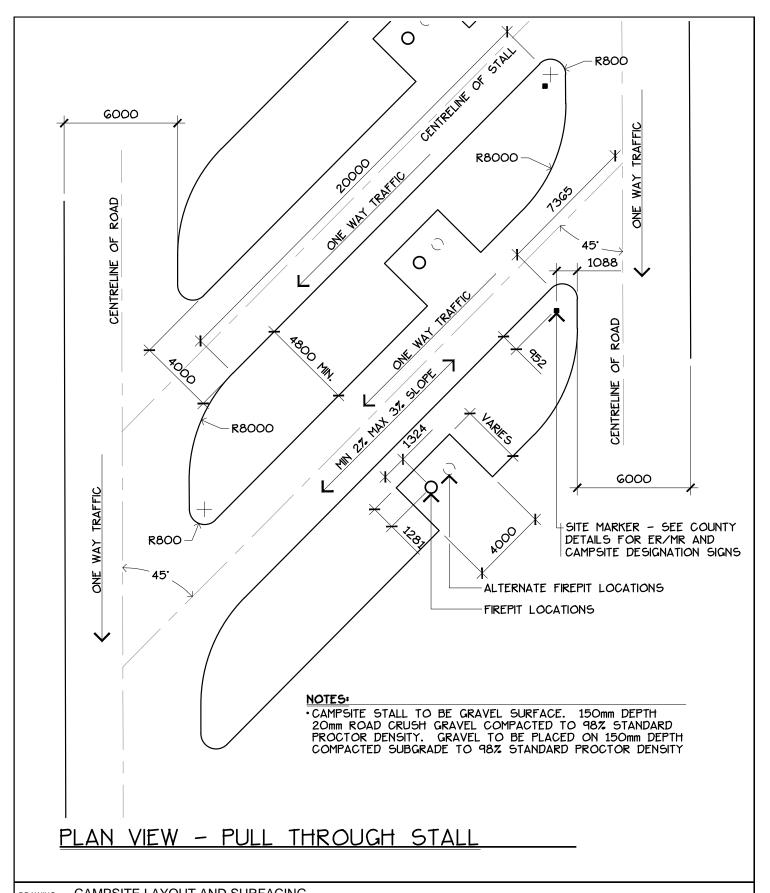


DRAWING: CAMPSI	<u>TE LAYOU</u>	JT AND SURFACING			
	REVISION NO:	:	DATE:	2009 08	DRAWING NO.
	DRAWN BY:	EARTHSCAPE CONSULTANTS	SCALE:	1:200	
COUNTY	CHECKED:	N.M.	APPROVED:	D.O.] 26B
LEDUC COUNTY F	PARKS AL	ND RECREATION SUITE 101, 1101	- 5th STREET I	NISKII ALBERTA TOE 2Y3]

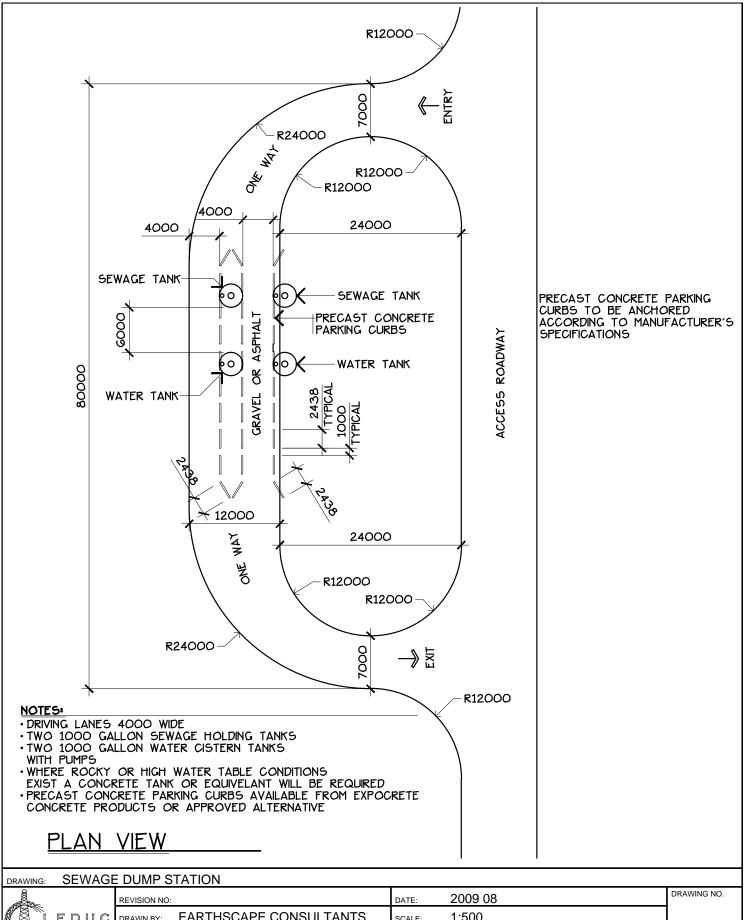

DRAWING: SEVVAGI	E DUIVIP 3	TATION				
	REVISION NO:			DATE:	2009 08	DRAWII
	DRAWN BY:	EARTHSCAPE CC	NSULTANTS	SCALE:	1:500	ہ ا
COUNTY	CHECKED:	N.M.		APPROVED:	D.O.	2
LEDUC COUNTY I	PARKS AN	ID RECREATION	SUITE 101, 1101	- 5th STREET, I	NISKU, ALBERTA, T9E 2X3	

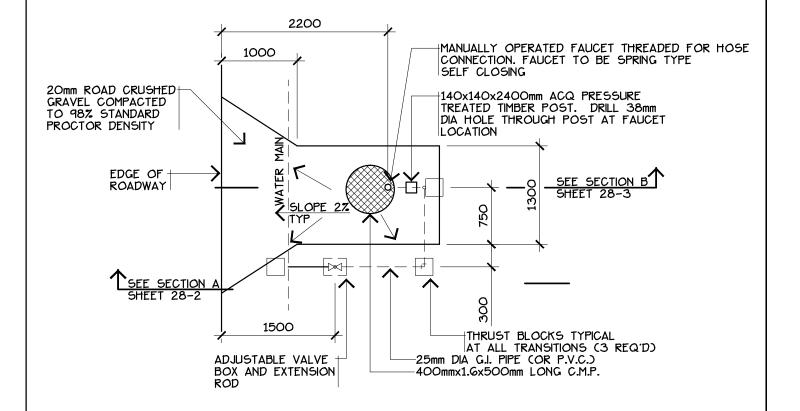



DRAWING: SEASON	AL WATE	R TAP & SUMP				
	REVISION NO:			DATE:	2009 08	DRAWING NO.
	DRAWN BY:	EARTHSCAPE CON	SULTANTS	SCALE:	1:50	00.4
COUNTY	CHECKED:	N.M.		APPROVED:	D.O.	28-1
LEDUC COUNTY F	ARKS AN	ND RECREATION	SUITE 101, 1101	- 5th STREET. N	VISKU, ALBERTA, T9E 2X3	 1

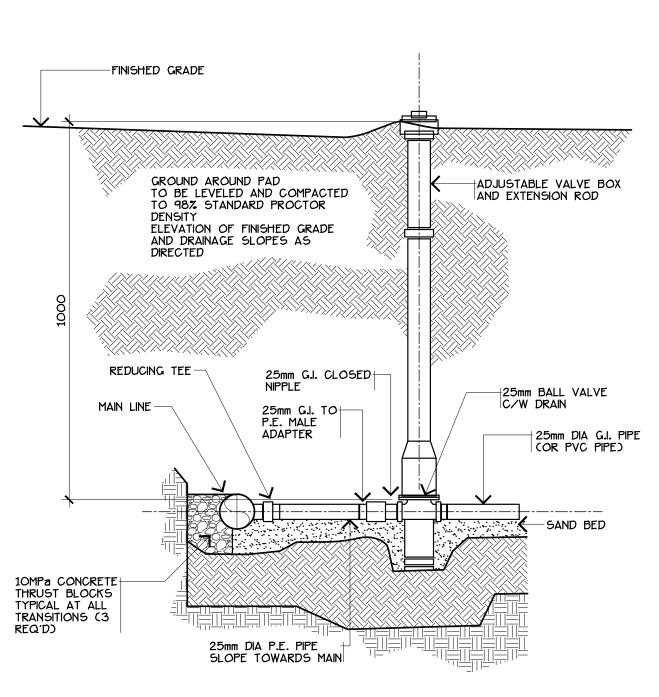

SECTION A

DRAWING: SEASON	<u>IAL WATE</u>	R TAP & SUMP				
	REVISION NO:			DATE:	2009 08	DRAWING NO.
LEDUC	DRAWN BY:	EARTHSCAPE CON	NSULTANTS	SCALE:	1:10]
COUNTY	CHECKED:	N.M.		APPROVED:	D.O.] 28-2
LEDUC COUNTY F	PARKS AN	ND RECREATION	SUITE 101, 1101	- 5th STREET. I	NISKU. ALBERTA. T9E 2X3	7

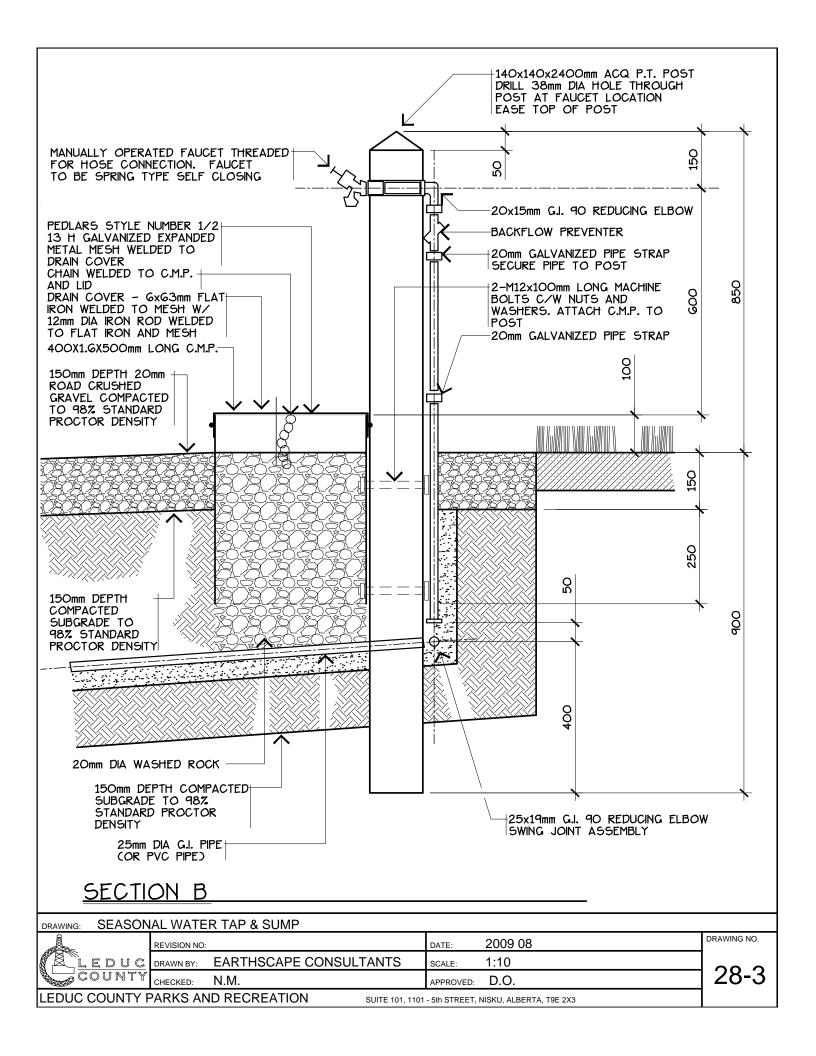

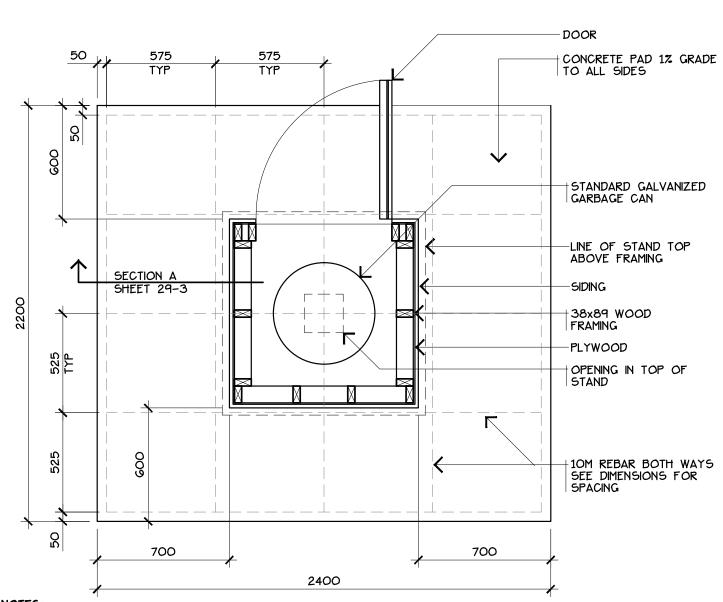


- •FRAMING MATERIALS CONSTRUCTION GRADE SPF. MAX. MOISTURE CONTENT 27%. ACQ PRESSURE TREATED AS NOTED
- NAILS. SCREWS TO BE GALVANIZED CEDAR SIDING SELECT TIGHT KNOT ROUGH SAWN CHANNEL. SIDING TO BE FINISHED W/ 2 COATS OF OLYMPIC SEMI-TRANSPARENT STAIN #716
- \cdot ACQ P.T. WOOD ALL CUT ENDS AND DRILLED HOLES TO BE FIELD TREATED W/ 2 COATS OF CLEAR ACQ WOOD PRESERVATIVE
- · 2 COATS OF WHITE ENAMEL ALL INTERIOR SURFACES
- ·CONCRETE PAD:

CONCRETE - CLASS C. TYPE GU. 30MPa • 28 DAYS. SLUMP 50-70. AIR ENTRAINED >5.5%. MAXIMUM 20mm AGGREGATE. MAXIMUM WATER 0.45. CEMENT 335kg/m3
BROOM FINISH SURFACE. EDGES TOOLED. 50mm TOOLED JOINTS MAXIMUM 3000mm O.C. 10M REBAR BOTH WAYS - SEE DIMENSIONS FOR SPACING 50mm DEEP LEVELLING SAND


150mm DEEP COMPACTED SUBGRADE TO 98% STANDARD PROCTOR DENSITY PROVIDE KEY LOCK FOR UNLOADING DOOR - ALL LOCKS KEYED TO COUNTY MASTER

PLAN

FISH CLEANING STAND DRAWING: DRAWING NO. REVISION NO: DATE: 2009 08 EARTHSCAPE CONSULTANTS 1:20 A LEDUC DRAWN BY: SCALE: COUNTY 29-1 CHECKED: N.M. D.O. APPROVED: LEDUC COUNTY PARKS AND RECREATION SUITE 101, 1101 - 5th STREET, NISKU, ALBERTA, T9E 2X3

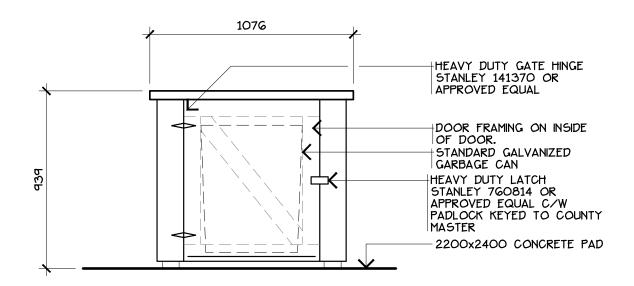


FRONT ELEVATION

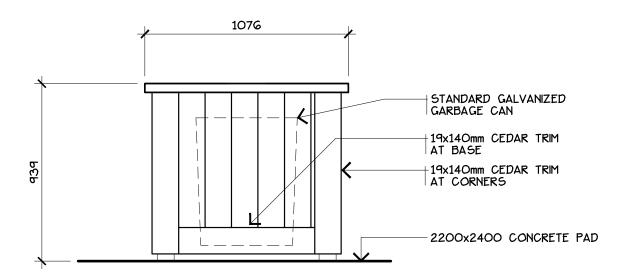

SIDE ELEVATION

DRAWING: FISH CLI	EANING S	TAND				
	REVISION NO:			DATE:	2009 08	DRAWING NO.
LEDUC	DRAWN BY:	EARTHSCAPE CONSU	JLTANTS	SCALE:	1:20	
COUNTY	CHECKED:	N.M.		APPROVED:	D.O.] 29-2
LEDUC COUNTY F	PARKS AN	JD RECREATION	SUITE 101 1101 -	5th STREET N	JISKII ALBERTA T9E 2X3	

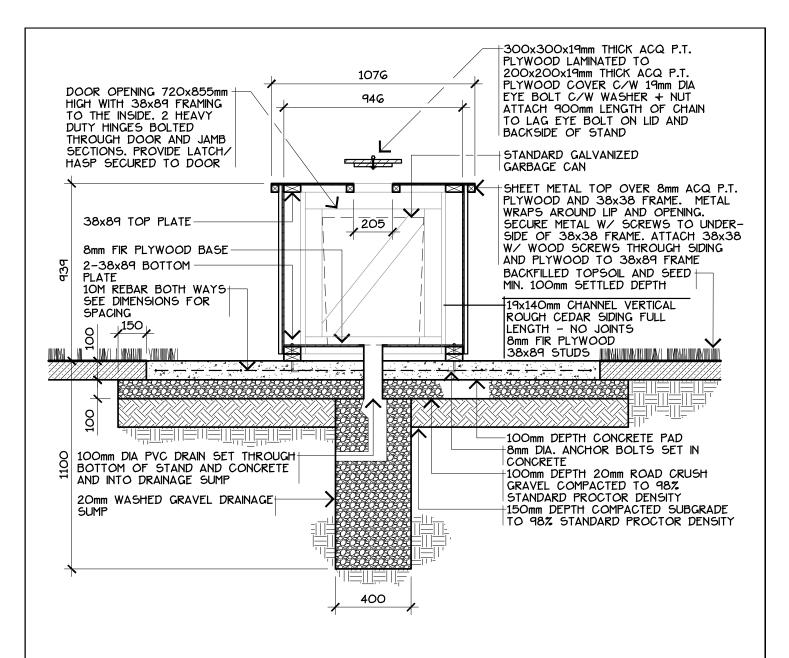


- •FRAMING MATERIALS CONSTRUCTION GRADE SPF. MAX. MOISTURE CONTENT 27%. ACQ PRESSURE TREATED AS NOTED •NAILS. SCREWS TO BE GALVANIZED •CEDAR SIDING SELECT TIGHT KNOT ROUGH SAWN CHANNEL. SIDING TO BE FINISHED W/ 2 COATS OF
- OLYMPIC SEMI-TRANSPARENT STAIN #716
- ·ACQ P.T. WOOD ALL CUT ENDS AND DRILLED HOLES TO BE FIELD TREATED W/ 2 COATS OF CLEAR ACQ WOOD PRESERVATIVE
- 2 COATS OF WHITE ENAMEL ALL INTERIOR SURFACES
- ·CONCRETE SLAB

CONCRETE - CLASS C. TYPE GU. 30MPa • 28 DAYS. SLUMP 50-70. AIR ENTRAINED >5.5%. MAXIMUM 20mm AGGREGATE. MAXIMUM WATER 0.45. CEMENT 335kg/m3 BROOM FINISH SURFACE. EDGES TOOLED. 50mm TOOLED JOINTS MAXIMUM 3000mm O.C. 10M REBAR BOTH WAYS - SEE DIMENSIONS FOR SPACING 50mm DEPTH LEVELLING SAND


150mm DEPTH COMPACTED SUBGRADE TO 98% STANDARD PROCTOR DENSITY


SECTION

D	RAWING: FISH CL	<u>EANING S</u>	STAND				
		REVISION NO:	:		DATE:	2009 08	DRAWING NO.
		DRAWN BY:	EARTHSCAPE CON	SULTANTS	SCALE:	1:20	
A. C.	COUNTY	CHECKED:	N.M.		APPROVED:	D.O.	29-3
Г	EDUC COUNTY F	PARKS AN	ND RECREATION	SUITE 101, 1101	- 5th STREET, I	NISKU, ALBERTA, T9E 2X3	

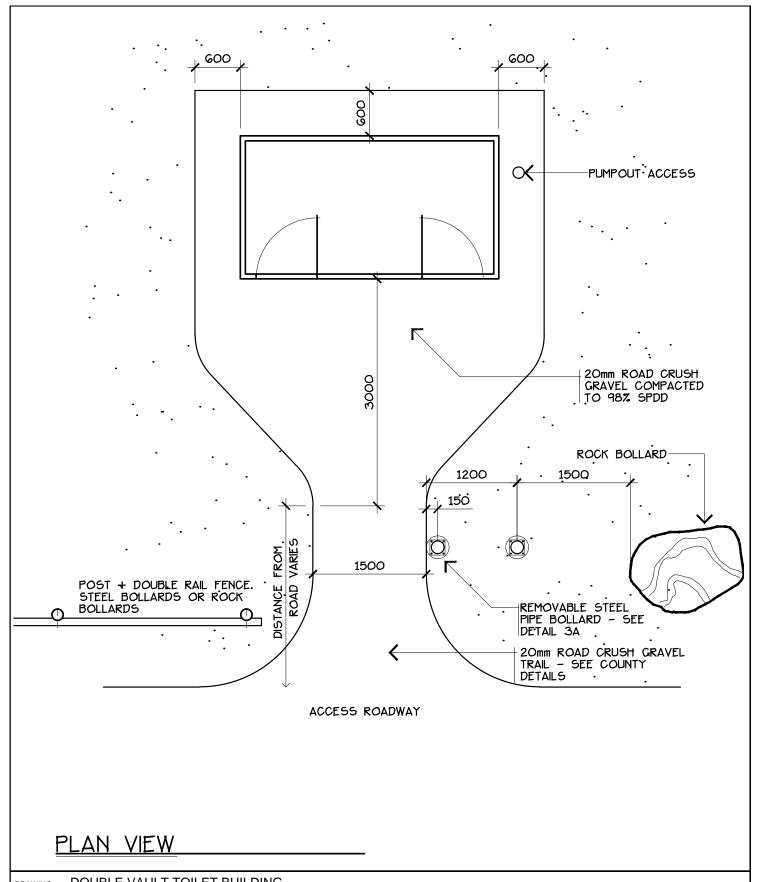

	DRAWING: DOUBLE	<u>: VAULI I</u>	OILE I BUILDING					
		REVISION NO:	:		DATE:	2009 08		DRAWING NO.
	LEDUC	DRAWN BY:	EARTHSCAPE CON	SULTANTS	SCALE:	1:50		00.4
Ľ	COUNTY	CHECKED:	N.M.		APPROVED:	D.O.		30-1
LEDUC COUNTY PARKS AND RECREATION SUITE 101, 1101 - 5th STREET, NISKU, ALBERTA, T9E 2X3								

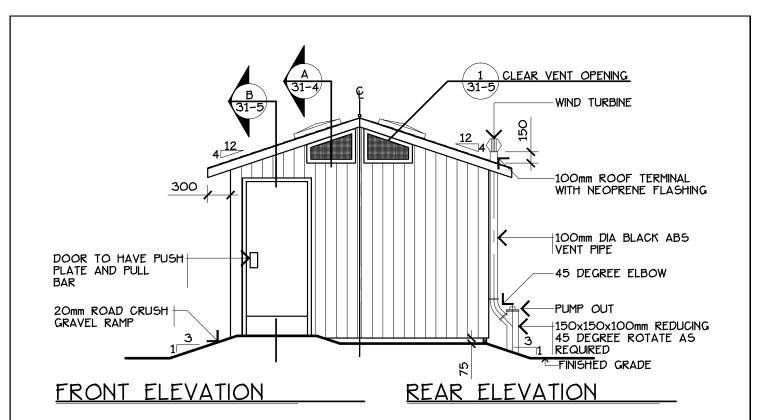

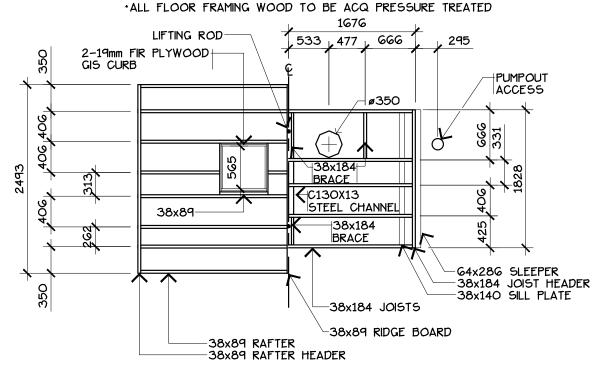


DOUBLE VAULT TOILET BUILDING - PLANS & ELEVATION


ROOF FRAMING PLAN

DRAWING:


	â		REVISION NO	:		DATE:	DATE: 2009 08		DRAWING NO.
		LEDUC	DRAWN BY:	EARTHSCAPE CO	ONSULTANTS	SCALE:	1:50		000
ľ		COUNTY	CHECKED:	N.M.		APPROVED:	D.O.		30-2
LEDUC COUNTY PARKS AND RECREATION SUITE 101, 1101 - 5th STREET, NISKU, ALBERTA, T9E 2X3									

FLOOR FRAMING PLAN

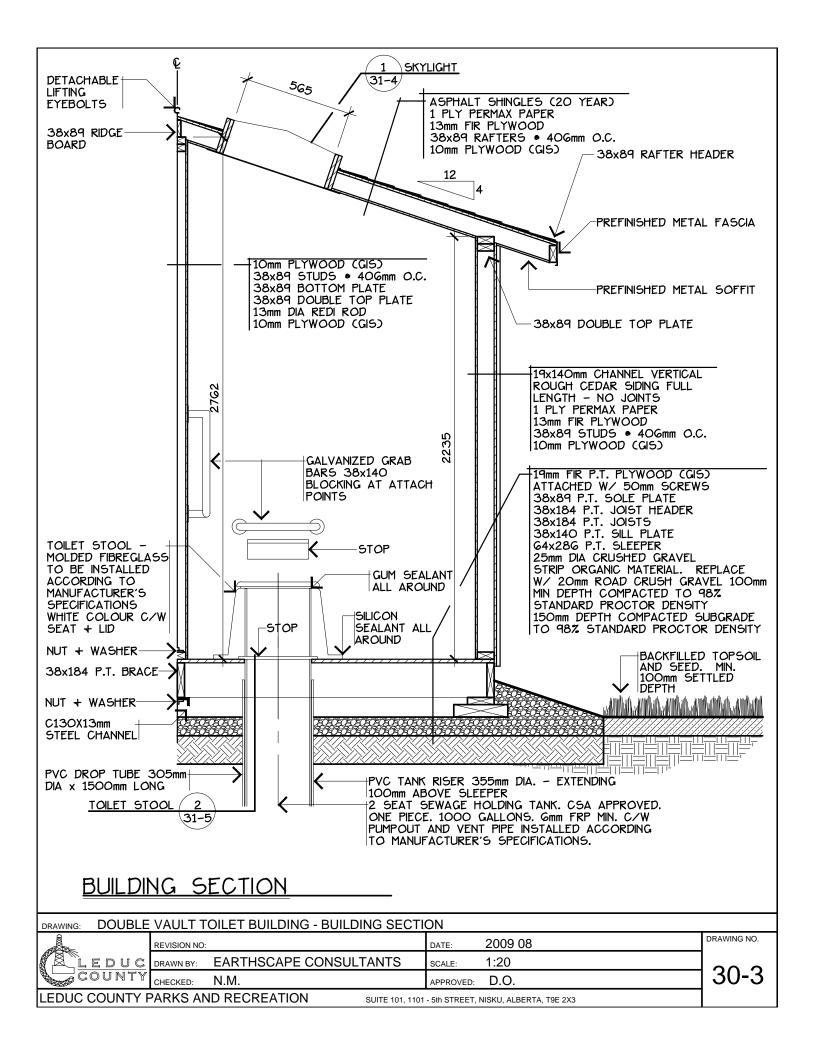

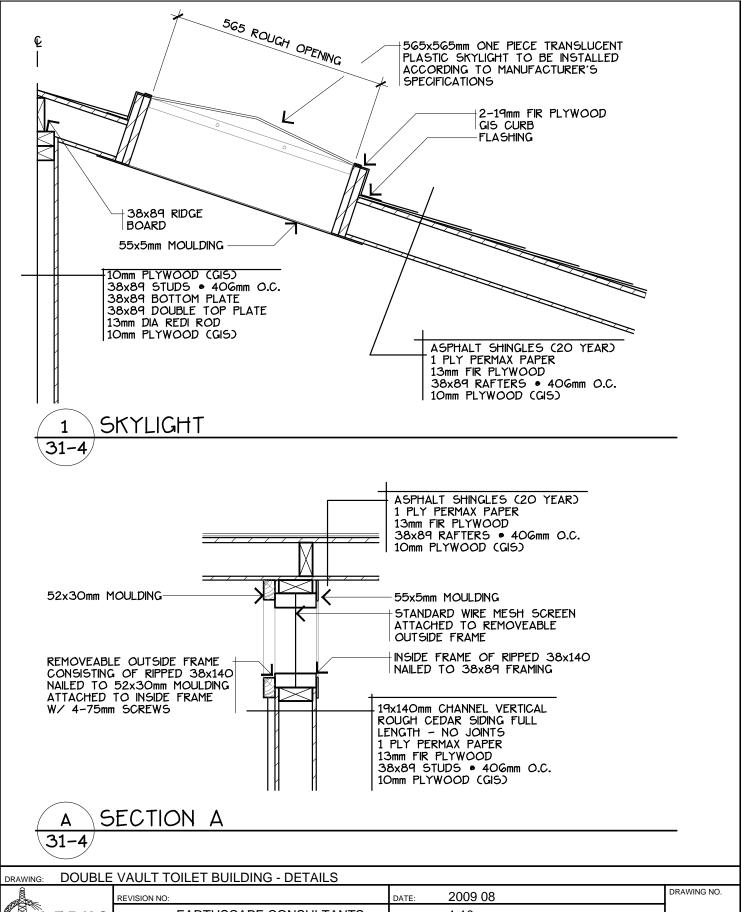

	REVISION NO:			DATE:	2009 08	DRAWING NO.
LEDUC	DRAWN BY:	EARTHSCAPE C	ONSULTANTS	SCALE:	1:10	00.4
LEDUC	CHECKED:	N.M.		APPROVED:	D.O.	30-4
LEDUC COUNTY F	PARKS AN	ND RECREATION	SUITE 101, 1101	- 5th STREET, I	NISKU, ALBERTA, T9E 2X3	

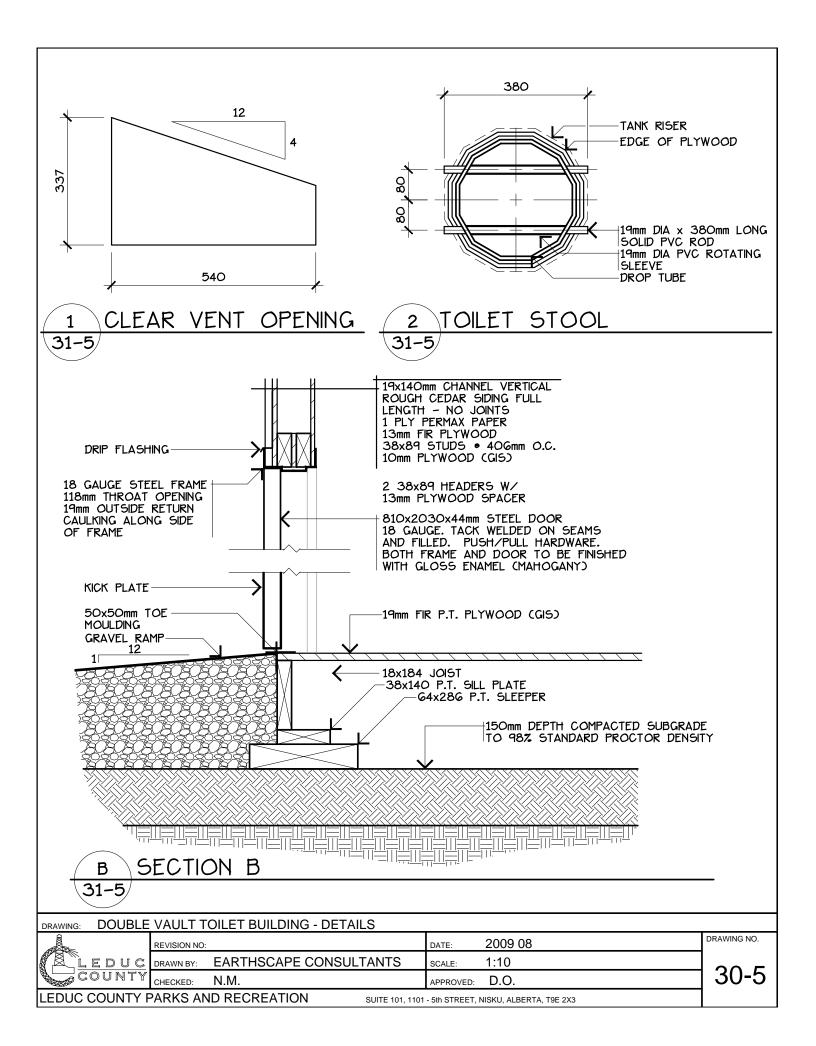

		ROOM	FLOOR		CEILING		WALLS		REMARKS	
		KOOM	MATERIAL	FIN.	MATERIAL	FIN.	MATERIAL	FIN.	KLIIAKIIS	
	INTERIOR	WASHROOM	19mm FIR PLYWOOD (GIS)	С	10mm FIR PLYWOOD (GIS)	В	10mm FIR PLYWOOD (GIS)	В	GRAB BARS TO BE INSTALLED IN BOTH COMPARTMENTS	
	EXTERIOR						VERTICAL ROUGH CEDAR	Α	DOOR SHALL BE EQUIPPED W/ PUSH PLATE + PULL BAR + CORBIN #0-30BL REVERSE BACKCHECK DOOR CLOSERS	

	DOORS			WINDOWS								
	FRAME		TRIM		TYPE		FRAME		TRIM			
MATERIAL FIN.		FIN.	MATERIAL	FIN.	MATERIAL	FIN.	MATERIAL	FIN.	MATERIAL	FIN.		
G	STEEL	G	STEEL	G	INSECT SCREEN		CEDAR	F	CEDAR	F		
FITTINGS			FLASHINGS		MECH. TRIM		SOFFIT		FASCIA			
FIN.	MATERIAL	FIN.	MATERIAL	FIN.	MATERIAL	FIN.	MATERIAL	FIN.	MATERIAL	FIN.		
D												
E	ASPHALT SHINGLES (20 YEAR)	н	PRE- FINISHED	ı			PREFINISHED METAL	F	PREFINISHED METAL	F		
	G S FIN. D	FRAME FIN. MATERIAL G STEEL S ROOF FIN. MATERIAL D ASPHALT SHINGLES	FIN. MATERIAL FIN. G STEEL G SS ROOF FIN. MATERIAL FIN. D ASPHALT SHINGLES H	FRAME TRIM FIN. MATERIAL FIN. MATERIAL G STEEL G STEEL G STEEL FIN. MATERIAL FIN. MATERIAL D ASPHALT SHINGLES H PRE- FINISHED	FRAME TRIM FIN. MATERIAL FIN. MATERIAL FIN. G STEEL G STEEL G SS ROOF FLASHINGS FIN. MATERIAL FIN. MATERIAL FIN. D ASPHALT SHINGLES H PRE-FINISHED I	FRAME TRIM TYPE FIN. MATERIAL FIN. MATERIAL FIN. MATERIAL G STEEL G STEEL G INSECT SCREEN SS ROOF FLASHINGS MECH. TR FIN. MATERIAL FIN. MATERIAL FIN. MATERIAL D ASPHALT SHINGLES H PRE-FINISHED I	FRAME TRIM TYPE FIN. MATERIAL FIN. MATERIAL FIN. MATERIAL FIN. G STEEL G STEEL G INSECT SCREEN SS ROOF FLASHINGS MECH. TRIM FIN. MATERIAL FIN. MATERIAL FIN. MATERIAL FIN. D ASPHALT SHINGLES H PRE-FINISHED I	FRAME TRIM TYPE FRAME FIN. MATERIAL FIN. MATERIAL FIN. MATERIAL G STEEL G STEEL G INSECT SCREEN G ROOF FLASHINGS MECH. TRIM SOFFIT FIN. MATERIAL FIN. MATERIAL FIN. MATERIAL D ASPHALT SHINGLES H PRE-FINISHED METAL	FRAME TRIM TYPE FRAME FIN. MATERIAL FIN. MATERIAL FIN. MATERIAL FIN. MATERIAL FIN. G STEEL G STEEL G INSECT SCREEN FRAME FIN. MATERIAL FIN. MATERIAL FIN. MATERIAL FIN. FIN. MATERIAL FIN. MATERIAL FIN. MATERIAL FIN. MATERIAL FIN. D ASPHALT SHINGLES H PRE-FINISHED FINISHED FINI	FRAME TRIM TYPE FRAME TRIM FIN. MATERIAL FIN. MATERIAL FIN. MATERIAL FIN. MATERIAL G STEEL G STEEL G INSECT SCREEN G ROOF FLASHINGS MECH. TRIM SOFFIT FASCIA FIN. MATERIAL FIN. MATERIAL FIN. MATERIAL D ASPHALT SHINGLES H PRE-FINISHED F PREFINISHED F METAL PREFINISHED F METAL		

- ALL FINISHES TO HAVE TWO COATS C/W PRIMER IN ACCORDANCE W/ MANUFACTURER'S SPECIFICATIONS A OLYMPIC SEMI-TRANSPARENT STAIN #716
- MOOR-O-MATIC SEMI GLOSS ALKYD ENAMEL #2-50
- MOORES PORCH + FLOOR ENAMEL 112-57 BAMBOO BEIGE
- AS PER MANUFACTURER'S SPECIFICATIONS
- ACRYLIC PLASTIC TRANSLUCENT
- OLYMPIC SOLID COLOUR STAIN MAHOGANY GENERAL PAINT ALKYD HOUSE + TRIM. GLOSS ENAMEL MAHOGANY NOTE: EXPOSED FLASHING TO BE ETCHED TO TAKE APPLIED FINISH
- CEDAR TONE

BROWN

MATERIALS

- FRAMING MATERIALS CONSTRUCTION GRADE SPF, MAX. MOISTURE CONTENT 27%, ACQ PRESSURE TREATED AS NOTED
- · NAILS. SCREWS AND STAPLES GALVANIZED IN EXTERIOR LOCATIONS
- · CEDAR SIDING SELECT TIGHT KNOT ROUGH SAWN CHANNEL


INSTALLATION

- ·CONFIRM BUILDING LOCATION AND CLEARING LIMITS WITH COUNTY PRIOR TO EXCAVATION
- · ESTABLISH THE LOCATION AND EXTENT OF UNDERGROUND UTILITIES PRIOR TO EXCAVATION
- ·CLEARING. GRUBBING AND EXCESS COMMON EXCAVATION TO BE DISPOSED OF OFF-SITE
- · NOTIFY COUNTY PRIOR TO BACKFILLING
- ·INSTALL HOLDING TANK AS PER MANUFACTURER'S INSTRUCTIONS. W/ VERTICAL RISERS 100mm ABOVE TOP OF SLEEPERS
- · BACKFILL MATERIALS TO THE BOTTOM OF SLEEPERS TO BE CRUSHED GRAVEL AS APPROVED BY THE COUNTY
- REMOVE ALL DEBRIS FROM THE SITE
 THE TOILET STALL SHALL HAVE 2 GRAB BARS. ONE ON THE SIDE WALL AND ONE ON THE BACK WALL AT LEAST
 GOOMM IN LENGTH. 25 TO 32mm DIA. TUBULAR BARS. WITH AT LEAST 45mm BETWEEN BARS AND WALLS. THE BAR ON SIDE WALL SHALL BE MOUNTED AT A GO DEGREE ANGLE TO THE FLOOR. AND 750mm ABOVE THE FLOOR. THE BAR ON REAR WALL SHALL BE CENTERED ON THE TOILET STOOL AND FIXED AT A LEVEL APPROX. 280mm ABOVE THE SEAT.

DOUBLE VAULT TOILET BUILDING - FINISH SCHEDULE


Г			REVISION NO:		DATE:	2009 08	DRAWING NO.
	COUNTY	LEDUC	DRAWN BY:	EARTHSCAPE CONSULTANTS	SCALE:	NTS	
A. C.		CHECKED:	N.M.	APPROVED:	D.O.	30-6	

LEDUC COUNTY PARKS AND RECREATION SUITE 101, 1101 - 5th STREET, NISKU, ALBERTA, T9E 2X3

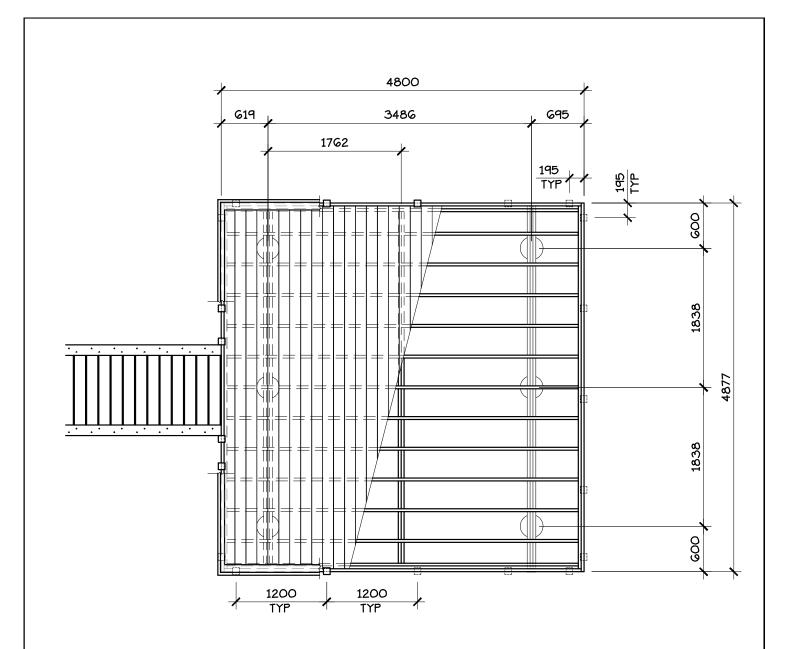

- •ALL WOOD TO BE ACQ PRESSURE TREATED SPF
 •ALL WOOD TO BE ALLOWED TO WEATHER.
 •FIELD TREAT ALL CUT ENDS AND DRILLED HOLES W/ 2 COATS
 CLEAR ACQ
- •ALL METAL HARDWARE TO BE GALVANIZED.
 •CONCRETE TO BE CLASS C TYPE GU 25MPa 28 DAYS

DRAWING: WILDLIF	<u>E VIEWIN</u>	G PLATFORM						
	REVISION NO:			DATE:	2009 08		DRAWING NO.	
	DRAWN BY:	EARTHSCAPE CONS	SULTANTS	SCALE:	1:50		04.4	
COUNTY	CHECKED:	N.M.		APPROVED:	D.O.		31-1	
LEDUC COUNTY PARKS AND RECREATION SUITE 101, 1101 - 5th STREET, NISKU, ALBERTA, T9E 2X3								

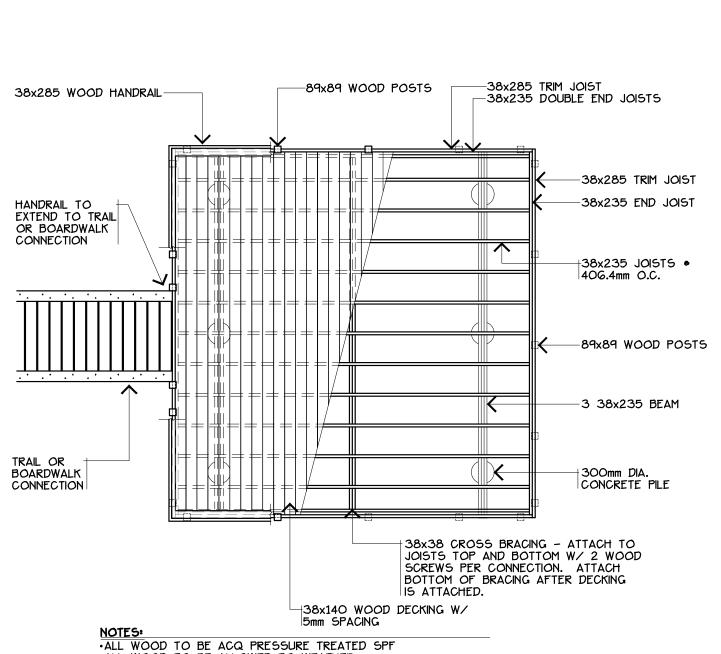

ALL WOOD TO BE ALLOWED TO WEATHER.

·FIELD TREAT ALL CUT ENDS AND DRILLED HOLES W/ 2 COATS CLEAR ACQ

·ALL METAL HARDWARE TO BE GALVANIZED.

•CONCRETE TO BE CLASS C TYPE GU 25MPa • 28 DAYS

PLAN VIEW

WILDLIFE VIEWING PLATFORM DRAWING: DRAWING NO. REVISION NO: DATE: 2009 08 LEDUC EARTHSCAPE CONSULTANTS 1:50 DRAWN BY: SCALE: 31-2 COUNTY N.M. D.O. CHECKED: APPROVED: LEDUC COUNTY PARKS AND RECREATION SUITE 101, 1101 - 5th STREET, NISKU, ALBERTA, T9E 2X3

